PROPOSED HOUSING AND EXISTING PUMP HOUSE EXTENSION. LAND EAST OF WINDERMERE AVENUE, COLNE, PENDLE.

Visually Verifiable Images. Views & Methodology by Visualhorizon3D

Designed by CPL ARCHITECTURE



30th September 2022

Contents

1.00	Introduction
2.00	View location selection
3.00	Views and technical data
4.00	Methodology: Overview
5.00	Methodology: Photography
6.00	Methodology: Surveying
7.00	Methodology: 3D Model & Camera matching
8.00	Methodology: Image creation and Post production

1.00 Introduction

- 1.1 The Visually Verifiable Images (VVIs) shown in this document are of the proposed new development at land east of Windermere Avenue, Colne, Pendle, designed by CPL ARCHITECTURE.
- 1.2 This document, and the VVIs of the project, was created by Visualhorizon3D
- 1.3 The purpose of this document is to present, in one document, proposed views, existing views and to describe the methodology used to create the finished VVIs.
- 1.4 The work was commissioned by CPL ARCHITECTURE with the view locations instructed by same. The brief was to create ten VVIs from these locations. The views are a mixture of wireline and fully rendered views, where appropriate (see section 4.1 for a description of view types).
- 1.5 All information regarding the development was supplied in digital format by CPL ARCHITECTURE, including plans, elevations, site plan and surveyors topographical survey.
- 1.6 The methods used to create the VVIs are in accordance with the guidelines for Landscape & Visual Impact Assessment (GLVIA) Third Edition 2013, together with TGN 06/19 (Technical Guidance Note 2019), produced by The Landscape Institute and Institute of Environmental Management & Assessment.
- 1.7 The methodology used to create these views is described in the methodology sections of this report (sections 5 to 8).
- 1.8 In some sections of this report where it is marked thus [#], please refer to the footnotes at the end of the relevant section for further information.

2.00 View location selection

- 2.1 The adjacent image (Fig. 2.11) indicates the viewpoint numbers and shows the relationship between the viewpoints and the site itself (highlighted blue).
- 2.3 The viewpoint numbers and descriptions are below.
 - View 1 Skipton Old Road, looking north east.
 - View 2 Skipton Old Road, looking north.
 - View 3 Skipton Old Road, looking south west.
 - View 4 Skipton Old Road, looking south west.
 - View 5 View from within site, looking south west.
 - View 6 View from within site, looking south east.
 - View 7 View from within site, looking south east.
 - View 8 View from within site, looking south east.
 - View 9 View from within site, looking south east.
 - View 10 Public footpath through fields south east of site, looking north west.



Figure 2.11

3.00 Views and technical data



Viewpoint 1 EXISTING

Visualisation Type Projection **Enlargement Factor**

4 Planar 100% @ A3 Date/Time of Photograph 13-07-2022 / 10.39

Camera Make, Model & sensor format: Nikon, D610 & Full Frame Sensor Make & focal length of Lens: Horizontal Filed of View (HFoV): 39.5 0 Direction of View from North (0°). 27.0

Nikkor 50mm

 Coordinates (Easting/Northing):
 390293.099 / 440464.601 M

 Height Above Ordnance Datum (AOD):
 183.275 M

 Distance to nearest site boundary / Feature:
 66 M

 Height of Camera:
 1.5 M

To be viewed at comfortable arm's length

Proposed Housing and Existing Pump House Extension. Land East of Windermere Avenue, Colne, Pendle. Designed by CPL ARCHITECTURE. Images produced by Visualinetizen3D



Viewpoint 1 PROPOSED

Visualisation Type Projection **Enlargement Factor**

4 Planar 100% @ A3 Date/Time of Photograph 13-07-2022 / 10.39

Camera Make, Model & sensor format: Nikon, D610 & Full Frame Sensor Make & focal length of Lens: Horizontal Filed of View (HFoV): 39.5 0 Direction of View from North (0°). 27.0

Nikkor 50mm

 Coordinates (Easting/Northing):
 390293.099 / 440464.601 M

 Height Above Ordnance Datum (AOD):
 183.275 M

 Distance to nearest site boundary / Feature:
 66 M

 Height of Camera:
 1.5 M

To be viewed at comfortable arm's length

Proposed Housing and Existing Pump House Extension. Land East of Windermere Avenue, Colne, Pendle. Designed by CPL ARCHITECTURE. Images produced by Visualinetizen3D

View 1



Surveyed points and data

Surveyed points an	d data ^o				
Point Number	Easting	Northing	Level AOD	Description	View location
V11	390308.732	440500.793	187.897	Bottom left M	
V12	390299.117	440484.477	189.687	Top right stone surround	Weather: Mostly sunny
V13	390298.812	440484.066	185.260	Top right stone surround	Visibility: Good
V14	390295.959	440480.207	186.074	Bottom right stone surround	
V21	390295.813	440470.911	182.150	Cnr IC frame	
V22	390295.638	440479.762	184.781	Top right stone surround	
V23	390295.635	440479.759	183.680	Bottom right stone surround	
V24	390294.972	440474.009	182.345	Nearest corner white mark	
V25	390294.409	440471.761	182.155	Furthest Cnr broken tarmac	
V26	390318.111	440518.464	189.798	Intersection curve and vertical gate post	
V28	390297.007	440481.637	188.763	Bottom left stone surround	
203T	390322.513	440525.992	190.149	Top of metal hinge	
209T	390327.928	440520.958	187.642	Cnr IC	
211T	390327.826	440522.669	189.073	Bottom rignt cnr stone	
215T	390324.176	440514.720	186.942	Cnr of drain	
305T	390320.599	440514.295	190.202	Top left cnr of sign	

Camera location





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Viewpoint 2 EXISTING

Visualisation Type 4 Projection **Enlargement Factor** Date/Time of Photograph 13-07-2022 / 10.23

Planar 100% @ A3

Camera Make, Model & sensor format: Nikon, D610 & Full Frame Sensor Make & focal length of Lens: Horizontal Filed of View (HFoV): 39.5 ° Direction of View from North (0°). 353 0

Nikkor 50mm

Coordinates (Easting/Northing): 390325.757 / 440507.758 M Height Above Ordnance Datum (AOD): 188.04 Distance to nearest site boundary / Feature: 15 M 188.043 M Height of Camera: 1.5 M

Proposed Housing and Existing Pump House Extension. Land East of Windermere Avenue, Colne, Pendle. Designed by CPL ARCHITECTURE. Images produced by Visualinetizin3D



Viewpoint 2 PROPOSED

Visualisation Type 4 Projection **Enlargement Factor**

Planar 100% @ A3 Date/Time of Photograph 13-07-2022 / 10.23

Camera Make, Model & sensor format: Nikon, D610 & Full Frame Sensor Make & focal length of Lens: Horizontal Filed of View (HFoV): Nikkor 50mm 39.5 ° Direction of View from North (0°). 353 0


Coordinates (Easting/Northing): Height Above Ordnance Datum (AOD): 188.04 Distance to nearest site boundary / Feature: 15 M Height of Camera: 1.5 M

390325.757 / 440507.758 M 188.043 M


Proposed Housing and Existing Pump House Extension. Land East of Windermere Avenue, Colne, Pendle. Designed by CPL ARCHITECTURE. Images produced by Visualhorizon3D

Camera location

View 2

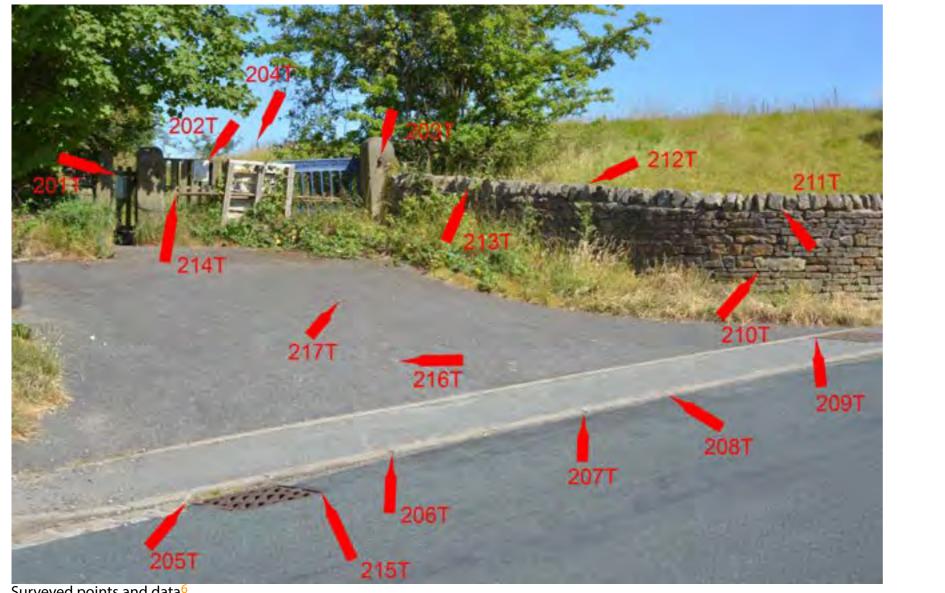

Surveyed points and data ^o Point Number	Easting	Northing	Level AOD	Description	
201T	390318.941	440524.723	189.743	Top left sign	
202T	390320.085	440525.333	190.021	Top right sign	Weat
203T	390322.513	440525.992	190.149	Top of metal hinge	
204T	390309.388	440565.891	195.504	Top of fence post	
205T	390323.429	440514.600	186.881	Cnr of drain	
206T	390324.413	440515.752	187.021	Intersection kerb joint and road	
207T	390325.621	440517.064	187.196	Intersection kerb joint and road	
208T	390326.274	440517.748	187.280	Intersection kerb joint and road	
209T	390327.928	440520.958	187.642	Cnr IC	
210T	390327.568	440522.718	188.368	Bottom left cnr stone	
211T	390327.826	440522.669	189.073	Bottom rignt cnr stone	
212T	390325.577	440523.828	189.488	Top right cnr stone	
213T	390324.529	440524.547	189.449	Bottom right cnr stone	
214T	390319.693	440525.098	189.492	Bottom cnr scaffold pole	
215T	390324.176	440514.720	186.942	Cnr of drain	
216T	390323.991	440518.586	187.473	Nearest point white mark	
217T	390322.929	440521.096	188.002	Nearest point white mark	

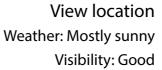







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Viewpoint 3 EXISTING

Visualisation Type Projection Enlargement Factor

4 Planar 100% @ A3 Date/Time of Photograph 13-07-2022 / 10.13 Camera Make, Model & sensor format: Nikon, D610 & Full Frame Sensor Make & focal length of Lens: Nikkor 50mm Horizontal Filed of View (HFoV): 39.5 ° Direction of View from North (0°). 230 0

Coordinates (Easting/Northing): 3903 Height Above Ordnance Datum (AOD): 191.3 Distance to nearest site boundary / Feature: 1 M 390369.157 / 440551.695 M 191.309 M Height of Camera: 1.5 M

To be viewed at comfortable arm's length

Proposed Housing and Existing Pump House Extension. Land East of Windermere Avenue, Colne, Pendle. Designed by CPL ARCHITECTURE. Images produced by Visual Portan 3D



Viewpoint 3 PROPOSED

Visualisation Type Projection Enlargement Factor


4 Planar 100% @ A3 Date/Time of Photograph 13-07-2022 / 10.13 Camera Make, Model & sensor format: Nikon, D610 & Full Frame Sensor Make & focal length of Lens: Nikkor 50mm Horizontal Filed of View (HFoV): 39.5 ° Direction of View from North (0°). 230 0

Coordinates (Easting/Northing): 3903 Height Above Ordnance Datum (AOD): 191.3 Distance to nearest site boundary / Feature: 1 M 390369.157 / 440551.695 M 191.309 M Height of Camera: 1.5 M

To be viewed at comfortable arm's length

Proposed Housing and Existing Pump House Extension. Land East of Windermere Avenue, Colne, Pendle. Designed by CPL ARCHITECTURE. Images produced by Visual Portan 3D

View 3

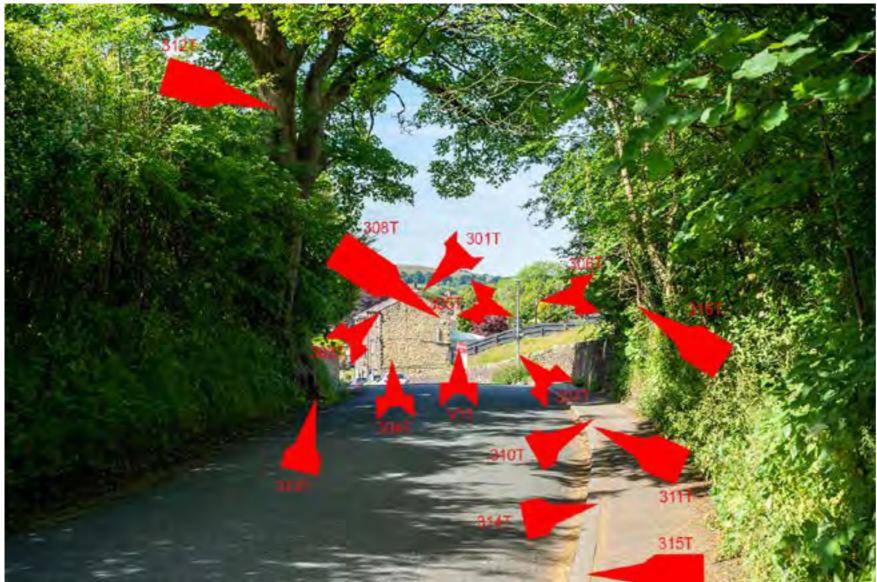

Surveyed points and data ⁶		N		-	
Point Number	Easting	Northing	Level AOD	Description	
V11	390308.732	440500.793	187.897	Bottom left M	We
301T	390297.584	440487.749	191.496	Top right cnr chimney stack	we
303T	390299.818	440485.260	189.997	Underside of eaves barge board	
304T	390299.140	440485.953	186.190	Top right cnr of vent	
305T	390320.599	440514.295	190.202	Top left cnr of sign	
306T	390289.005	440492.359	190.745	Top right cnr of large glass on lamp	
307T	390320.502	440514.464	188.381	Top centre of white sign on lamp post	
308T	390296.578	440488.976	189.322	Top right cnr of alarm	
310T	390351.749	440539.948	189.240	Cnr of IC	
311T	390352.530	440540.441	189.252	Top of kerb line intersection with tarmac	
312T	390350.720	440530.882	195.315	Top left dark patch on tree	
313T	390349.205	440530.642	188.829	Centre of root base	
314T	390355.532	440542.622	189.343	Top of kerb line intersection with tarmac	
315T	390357.818	440544.175	189.425	Top of kerb line intersection with tarmac	
316T	390351.322	440540.554	191.169	Bottom cnr of bend in larger branch	

Camera location

View location /eather: Mostly sunny Visibility: Good







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Viewpoint 4 EXISTING

Visualisation Type Projection Enlargement Factor

4 Planar 100% @ A3 Date/Time of Photograph 13-07-2022 / 07.48

Camera Make, Model & sensor format: Nikon, D610 & Full Frame Sensor Make & focal length of Lens: Horizontal Filed of View (HFoV): Direction of View from North (0°):

Nikkor 50mm 39.5 % 224 0

Coordinates (Easting/Northing): Height Above Ordnance Datum (AOD): 201.65 Distance to nearest site boundary / Feature: 8.5 M Height of Camera:

390487.308 / 440635.019 M 201.657 M 1.5 M

To be viewed at comfortable arm's length

Proposed Housing and Existing Pump House Extension. Land East of Windermere Avenue, Colne, Pendle. Designed by CPL ARCHITECTURE, Images produced by Visual 3D



Viewpoint 4 PROPOSED

Visualisation Type Projection Enlargement Factor

4 Planar 100% @ A3 Date/Time of Photograph 13-07-2022 / 07.48

Camera Make, Model & sensor format: Nikon, D610 & Full Frame Sensor Make & focal length of Lens: Horizontal Filed of View (HFoV): Direction of View from North (0°):

Nikkor 50mm 39.5 % 224 0

Coordinates (Easting/Northing): Height Above Ordnance Datum (AOD): 201.65 Distance to nearest site boundary / Feature: 8.5 M Height of Camera:

390487.308 / 440635.019 M 201.657 M 1.5 M

To be viewed at comfortable arm's length

Proposed Housing and Existing Pump House Extension. Land East of Windermere Avenue, Colne, Pendle. Designed by CPL ARCHITECTURE, Images produced by Visual 3D

View 4



Surveyed points and data⁶

Surveyed points and data				
Point Number	Easting	Northing	Level AOD	Description
417T	390470.137	440614.169	198.596	Top centre gas pipe
418T	390462.591	440615.355	202.146	End of lamp post light
419T	390455.698	440615.763	201.048	Top centre fence post
420T	390459.127	440615.396	199.627	Top centre fence post
421T	390464.265	440620.190	200.043	Top centre fence post
422T	390462.287	440615.627	198.022	Centre of lock nut
423T	390465.918	440609.396	198.365	Top right of stone
424T	390473.814	440626.871	198.642	Intersection kerb joint and
425T	390472.699	440625.404	198.454	Intersection kerb joint and
426T	390468.696	440620.578	197.767	Intersection kerb joint and
427T	390475.545	440619.400	198.382	Intersection top of pipe an
428T	390478.851	440623.192	198.943	Intersection top of pipe an
429T	390459.049	440603.585	196.598	Intersection of wall split ar
430T	390470.737	440624.910	199.153	Bottom right of stone
431T	390467.589	440621.113	198.085	Top of stone joint

nd road nd road nd road and wall and wall and road

Camera location

View location Weather: Mostly sunny Visibility: Good







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Viewpoint 5 EXISTING

Visualisation Type 4 Projection Planar **Enlargement Factor** 100% @ A3 Date/Time of Photograph 13-07-2022 / 09.37

Make & focal length of Lens: Horizontal Filed of View (HFoV): Direction of View from North (0°): 2140

Camera Make, Model & sensor format: Nikon, D610 & Full Frame Sensor Nikkor 50mm 39.5 °

Coordinates (Easting/Northing): 390398.948 / 440649.238 M Height Above Ordnance Datum (AOD): 203.2 Distance to nearest site boundary / Feature: 0 M 203.290 M Height of Camera: 1.722 M*

* Original photo height chosen with the aim being to give a reasonable eye level height in proposed view, once 3D Model is overfaid. Note. Proposed path levels on design drawings changed post photography site visit

To be viewed at comfortable arm's length

Proposed Housing and Existing Pump House Extension. Land East of Windermere Avenue, Colne, Pendle. Designed by CPL ARCHITECTURE. Images produced by Visualhorizon3D



Viewpoint 5 PROPOSED

Visualisation Type 4 Projection Planar **Enlargement Factor** 100% @ A3 Date/Time of Photograph 13-07-2022 / 09.37

Make & focal length of Lens: Horizontal Filed of View (HFoV): Direction of View from North (0°).

Camera Make, Model & sensor format: Nikon, D610 & Full Frame Sensor Nikkor 50mm 39.5 ° 214.0

Coordinates (Easting/Northing): Height Above Ordnance Datum (AOD): 203.2 Distance to nearest site boundary / Feature: 0 M Height of Camera:

390398.948 / 440649.238 M 203.290 M 2.050 M*

*Camera height when completed 3D model overlaid on photograph. Note: Proposed path levels on design drawings changed post photography site visit

To be viewed at comfortable arm's length

Proposed Housing and Existing Pump House Extension. Land East of Windermere Avenue, Colne, Pendle. Designed by CPL ARCHITECTURE. Images produced by Visualinettain3D

View 5



<i>c</i>		• •		1 1 6
Survey	ved	points	and	data
Juive	yca	points	unu	aata

Surveyed point Point Number	Easting	Northing	Level AOD	Description
1T	390393.490	440638.979	201.390	Target
2T	390392.254	440635.328	201.147	Target
3T	390390.373	440638.195	201.330	Target
4T	390387.667	440636.833	201.167	Target
5T	390388.762	440633.455	201.063	Target
6T	390391.886	440629.208	200.687	Target
7T	390389.596	440628.165	200.592	Target
8T	390386.493	440627.629	200.556	Target
9T	390383.260	440632.852	200.867	Target
10T	390351.050	440567.504	198.559	Apex of stone circle
11T	390348.548	440571.030	198.495	Top far right cnr chimney
12T	390344.125	440570.441	196.823	Top far right cnr stone
13T	390296.685	440531.808	200.376	Top left cnr chimney
14T	390289.484	440542.012	201.329	Top left cnr chimney
15T	390283.509	440546.780	198.175	Bottom cnr grey roof verge
16T	390351.921	440566.099	195.066	Top left cnr cill
17T	390291.592	440548.100	195.179	Top right cnr door surround



View location Weather: Mostly sunny Visibility: Good







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Viewpoint 6 EXISTING

Visualisation Type 4 Projection Planar **Enlargement Factor** 100% @ A3 Date/Time of Photograph 13-07-2022 / 16.19

Make & focal length of Lens: Horizontal Filed of View (HFoV): 39.5 ° Direction of View from North (0°): 123.0

Camera Make, Model & sensor format: Nikon, D610 & Full Frame Sensor Nikkor 50mm

Coordinates (Easting/Northing): Height Above Ordnance Datum (AOD): 212.2 Distance to nearest site boundary / Feature: 0 M Height of Camera:

390408.041 / 440764.258 M 212.249 M 1.65 M*

* Original photo height chosen with the aim being to give a reasonable eye level height in proposed view, once 3D Model is overlald

To be viewed at comfortable arm's length

Proposed Housing and Existing Pump House Extension. Land East of Windermere Avenue, Colne, Pendle. Designed by CPL ARCHITECTURE. Images produced by Visualinettain3D



Viewpoint 6 PROPOSED

Visualisation Type	4
Projection	Planar
Enlargement Factor	100% @ A3
Date/Time of Photograph	13-07-2022 / 16.19

Camera Make, Model & sensor format: Nikon, D610 & Full Frame Sensor Make & focal length of Lens: Horizontal Filed of View (HFoV): Direction of View from North (0°):

Nikkor 50mm 39.5 9 123.0

 Coordinates (Easting/Northing):
 39040

 Height Above Ordnance Datum (AOD):
 212.2

 Distance to nearest site boundary / Feature:
 0 M

 Height of Camera:
 1.5 M

 1.5 M*

390408.041 / 440764.258 M 212.249 M

*Camera height when completed 3D model overlaid on photograph

To be viewed at comfortable arm's length

Proposed Housing and Existing Pump House Extension. Land East of Windermere Avenue, Colne, Pendle. Designed by CPL ARCHITECTURE. Images produced by Visualhorizon3D

Camera location

View 6



Surveye	ed poir	nts and	data ⁶
		its arra	aaca

Surveyed points and data ^v	Easting	Northing	Level AOD	Description
601T	390412.666	440762.275	211.170	Target
602T	390412.849	440759.889	210.920	Target
				5
603T	390413.828	440760.098	211.042	Target
604T	390413.719	440760.880	211.131	Target
605T	390416.529	440759.665	211.103	Target
606T	390418.717	440760.810	211.179	Target
607T	390440.436	440751.308	210.320	Target
608T	390444.494	440749.567	210.327	Target
611T	390419.260	440754.219	210.783	Target
612T	390417.707	440753.715	210.719	Target
613T	390495.652	440714.612	210.015	Top left cnr window opening
614T	390493.484	440711.090	209.992	Top right cnr door opening
615T	390482.948	440693.366	208.708	Top right cnr door opening
716T	390502.933	440714.373	215.843	Bottom cnr ridge tiles
717T	390500.203	440709.846	215.891	Bottom cnr ridge tiles
718T	390493.372	440698.504	213.987	Bottom cnr ridge tiles
719T	390491.484	440695.357	213.967	Bottom cnr ridge tiles
720T	390519.702	440666.970	213.620	Apex of roof
⁶ See footnotes, section 6.00 for furt	ther reading of Eastings, No.	rthings and Level AOSD		







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Viewpoint 7 EXISTING

Visualisation Type 4 Projection Planar **Enlargement Factor** 100% @ A3 Date/Time of Photograph 13-07-2022 / 14.30

Make & focal length of Lens: Horizontal Filed of View (HFoV): Direction of View from North (0°). 1450

Camera Make, Model & sensor format: Nikon, D610 & Full Frame Sensor Nikkor 50mm 39.5°

Coordinates (Easting/Northing): Height Above Ordnance Datum (AOD): 209.5 Distance to nearest site boundary / Feature: 0 M Height of Camera:

390347.851 / 440731.943 M 209.568 M 1.76 M*

* Original photo height chosen with the aim being to give a reasonable eye level height in proposed view, once 3D Model is overfaild

To be viewed at comfortable arm's length

Proposed Housing and Existing Pump House Extension. Land East of Windermere Avenue, Colne, Pendle. Designed by CPL ARCHITECTURE. Images produced by Visualhertzin3D



Viewpoint 7 PROPOSED

Visualisation Type	4
Projection	Planar
Enlargement Factor	100% @ A3
Date/Time of Photograph	13-07-2022 / 14.30

Camera Make, Model & sensor format: Nikon, D610 & Full Frame Sensor Make & focal length of Lens: Horizontal Filed of View (HFoV): Direction of View from North (0°).

Nikkor 50mm 39.5 ° 1450

390347.851 / 440731.943 M 209.568 M Coordinates (Easting/Northing): Height Above Ordnance Datum (AOD): 209.5 Distance to nearest site boundary / Feature: 0 M Height of Camera: 1.49 M*

*Camera height when completed 3D model overlaid on photograph

To be viewed at comfortable arm's length

Proposed Housing and Existing Pump House Extension. Land East of Windermere Avenue, Colne, Pendle. Designed by CPL ARCHITECTURE. Images produced by Visualhorizon3D

Camera location


View 7

701T

702T

703T 704T


705T 706T 707T 708T 709T 710T 711T 712T 713T 714T 715T 723T 724T

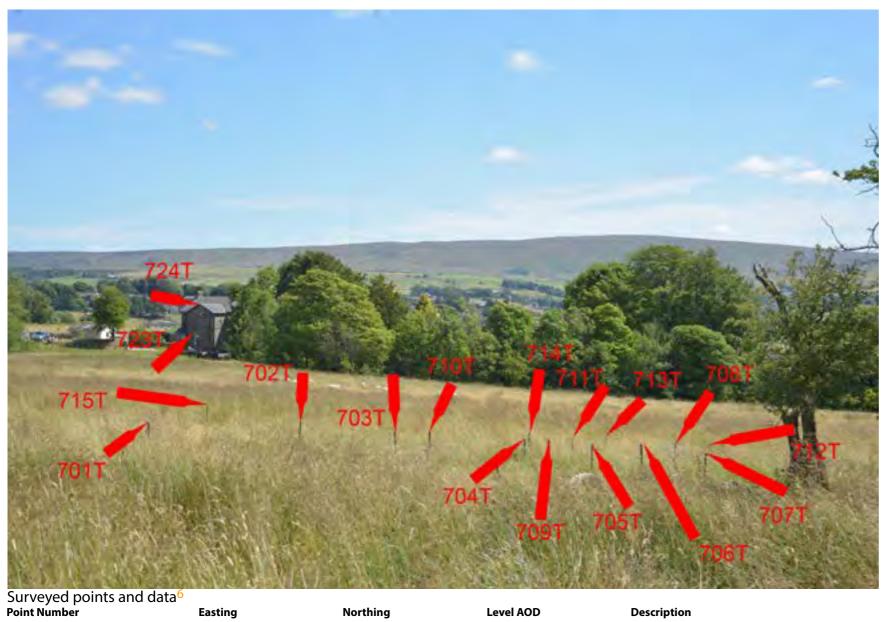

and data ⁶	CHEN MERAL THE			
	Easting	Northing	Level AOD	Description
	390366.991	440714.765	207.109	Target
	390364.674	440712.817	207.107	Target
	390362.963	440711.921	206.943	Target
	390360.279	440710.422	206.827	Target
	390359.135	440710.753	206.849	Target
	390358.271	440710.429	206.875	Target
	390356.799	440710.826	206.842	Target
	390358.879	440707.546	206.611	Target
	390361.678	440709.019	206.624	Target
	390363.691	440709.694	206.720	Target
	390362.079	440706.216	206.390	Target
	390359.221	440704.937	206.310	Target
	390362.903	440702.989	206.091	Target
	390364.049	440704.866	206.280	Target
	390373.270	440706.980	206.602	Target
	390488.401	440596.705	204.717	Top left cnr stonework

208.882

Top left elli storiework	
Underside apex barge board	

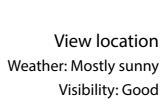



390487.223

440596.816





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Viewpoint 8 EXISTING

Visualisation Type 4 Projection Planar **Enlargement Factor** 100% @ A3 Date/Time of Photograph 10-08-2022 / 09.20

Make & focal length of Lens: Horizontal Filed of View (HFoV): Direction of View from North (0°): 124 0

Camera Make, Model & sensor format: Nikon, D610 & Full Frame Sensor Nikkor 50mm 39.5 °

Coordinates (Easting/Northing): 390310.368 / 440828.129 M Height Above Ordnance Datum (AOD): 214.7 Distance to nearest site boundary / Feature: 0 M 214,75 M Height of Camera: 1.74 M*

* Original photo height chosen with the aim being to give a reasonable eye level height in proposed view, once 3D Model is overfaid

To be viewed at comfortable arm's length

Proposed Housing and Existing Pump House Extension. Land East of Windermere Avenue, Colne, Pendle. Designed by CPL ARCHITECTURE. Images produced by Visualinetizen3D



Viewpoint 8 PROPOSED

Visualisation Type	4
Projection	Planar
Enlargement Factor	100% @ A3
Date/Time of Photograph	10-08-2022/09.20

*Camera height when completed 3D model overlaid on photograph

 Camera Make, Model & sensor format:
 Nikon, D610 & Full Frame Sensor

 Make & focal length of Lens:
 Nikkor 50mm

 Horizontal Filed of View (HFoV):
 39.5 °

 Direction of View from North (0°):
 124 °

 Coordinates (Easting/Northing):
 390310.368 / 440828.129 M

 Height Above Ordnance Datum (AOD):
 214.75 M

 Distance to nearest site boundary / Feature:
 0 M

 Height of Camera:
 1.55 M*

To be viewed at comfortable arm's length

Proposed Housing and Existing Pump House Extension. Land East of Windermere Avenue, Colne, Pendle. Designed by CPL ARCHITECTURE. Images produced by Visualinetizen3D

Camera location

View 8



Surveyed points and data⁶

Surveyed points and data ^o							
Point Number	Easting	Northing	Level AOD	Description			
801T	390374.425	440798.036	213.375	Target			
803T	390374.545	440792.146	213.032	Target			
804T	390376.651	440793.432	212.984	Target			
805T	390376.646	440789.577	212.797	Target			
806T	390381.996	440793.605	213.070	Target			
807T	390382.368	440789.775	212.841	Target			
808T	390383.725	440784.567	212.515	Target			
809T	390389.245	440776.923	212.000	Target			
613T	390495.652	440714.612	210.015	Top left cnr window opening			
614T	390493.484	440711.090	209.992	Top right cnr door opening			
615T	390482.948	440693.366	208.708	Top right cnr door opening			
716T	390502.933	440714.373	215.843	Bottom cnr ridge tiles			
717T	390500.203	440709.846	215.891	Bottom cnr ridge tiles			
718T	390493.372	440698.504	213.987	Bottom cnr ridge tiles			
719T	390491.484	440695.357	213.967	Bottom cnr ridge tiles			
720T	390519.702	440666.970	213.620	Apex of roof			

View location Weather: Mostly sunny Visibility: Good







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Viewpoint 9 EXISTING

Visualisation Type 4 Projection Planar **Enlargement Factor** 100% @ A3 Date/Time of Photograph 13-07-2022 / 15.30

Make & focal length of Lens: Horizontal Filed of View (HFoV): Direction of View from North (0°).

Camera Make, Model & sensor format: Nikon, D610 & Full Frame Sensor Nikkor 50mm 39.5 9 141 0

Coordinates (Easting/Northing): 390261.222 / 440677.352 M Height Above Ordnance Datum (AOD): 203.9 Distance to nearest site boundary / Feature: 0 M 203.96 M Height of Camera: 1.5 M*

* New location instructed by architect on day of photography, due to trees completely obscuring original location.

Proposed Housing and Existing Pump House Extension. Land East of Windermere Avenue, Colne, Pendle. Designed by CPL ARCHITECTURE. Images produced by Visualinetizen3D



Viewpoint 9 PROPOSED

Visualisation Type	4
Projection	Planar
Enlargement Factor	100% @ A3
Date/Time of Photograph	13-07-2022/15.30

Camera Make, Model & sensor format: Nikon, D610 & Full Frame Sensor Make & focal length of Lens: Nikkor 50mm Horizontal Filed of View (HFoV): 39.5 ° Direction of View from North (0°).

141 0

Coordinates (Easting/Northing): 3902 Height Above Ordnance Datum (AOD): 203.9 Distance to nearest site boundary / Feature: 0 M Height of Camera:

390261.222 / 440677.352 M 203.96 M 1.86 M*

*Camera height when completed 3D model overlaid on photograph


To be viewed at comfortable arm's length

Proposed Housing and Existing Pump House Extension. Land East of Windermere Avenue, Colne, Pendle. Designed by CPL ARCHITECTURE. Images produced by Visualinetizen3D

Land East of Windermere Avenue, Colne, Pendle.

Camera location

View 9

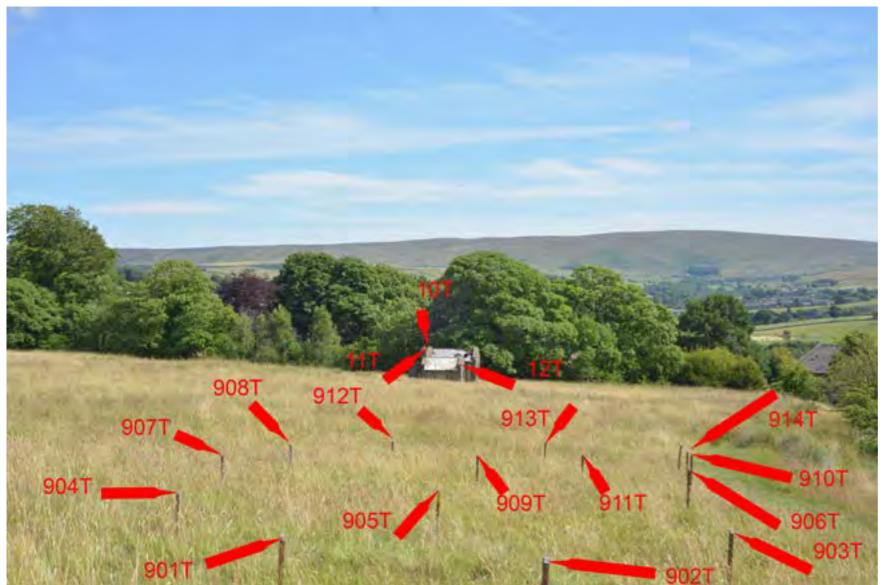

Surveyed	points	and	data

Point Number	Easting	Northing	Level AOD	Description
10T	390351.050	440567.504	198.559	Apex of stone circle
11T	390348.548	440571.030	198.495	Top far right cnr chimney
12T	390344.125	440570.441	196.823	Top far right cnr stone
901T	390266.430	440672.304	202.584	Target
902T	390265.183	440671.441	202.482	Target
903T	390265.786	440667.818	202.055	Target
904T	390269.599	440670.453	202.306	Target
905T	390269.070	440667.576	202.040	Target
906T	390268.953	440662.471	201.723	Target
907T	390273.030	440666.933	202.023	Target
908T	390275.003	440663.814	201.723	Target
909T	390273.072	440661.629	201.500	Target
910T	390270.833	440658.769	201.418	Target
911T	390273.173	440658.375	201.193	Target
912T	390276.170	440660.072	201.373	Target
913T	390275.644	440655.883	201.026	Target
914T	390274.126	440652.896	200.806	Target



View location Weather: Mostly sunny Visibility: Good



Visualhorizon3D - Visually Verifiable Images: Views & Methodology





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Viewpoint 10 EXISTING

Visualisation Type Projection **Enlargement Factor**

4 Planar 100% @ A3 Date/Time of Photograph 13-07-2022 / 12.03

Camera Make, Model & sensor format: Nikon, D610 & Full Frame Sensor Make & focal length of Lens: Horizontal Filed of View (HFoV): Direction of View from North (0°).

Nikkor 50mm 39.5 ° 3120

Coordinates (Easting/Northing): Height Above Ordnance Datum (AOD): 204.914 Distance to nearest site boundary / Feature: 110 M Height of Camera:

390562.192 / 440562.614 M 204.914 M 1.5 M

To be viewed at comfortable arm's length

Proposed Housing and Existing Pump House Extension. Land East of Windermere Avenue, Colne, Pendle. Designed by CPL ARCHITECTURE. Images produced by Visualinettain3D



Viewpoint 10 PROPOSED

Visualisation Type Projection **Enlargement Factor**

4 Planar 100% @ A3 Date/Time of Photograph 13-07-2022 / 12.03

Camera Make, Model & sensor format: Nikon, D610 & Full Frame Sensor Make & focal length of Lens: Horizontal Filed of View (HFoV): Direction of View from North (0°).

Nikkor 50mm 39.5 0 3120

Coordinates (Easting/Northing): Height Above Ordnance Datum (AOD): 204.914 Distance to nearest site boundary / Feature: 110 M Height of Camera:

390562.192 / 440562.614 M 204.914 M 1.5 M

To be viewed at comfortable arm's length

Proposed Housing and Existing Pump House Extension. Land East of Windermere Avenue, Colne, Pendle. Designed by CPL ARCHITECTURE. Images produced by Visualinettain3D

Land East of Windermere Avenue, Colne, Pendle.

Camera location

View 10



Surveyed points and data	6			
Point Number	Easting	Northing	Level AOD	Description
101T	390557.105	440568.115	203.975	Target
102T	390555.097	440569.130	203.837	Target
103T	390555.677	440570.379	203.923	Target
104T	390555.952	440572.892	203.997	Target
105T	390553.153	440573.149	203.947	Target
106T	390551.833	440570.314	203.825	Target
107T	390552.936	440569.135	203.804	Target
108T	390553.022	440567.612	203.795	Target
109T	390549.192	440570.225	203.764	Target
110T	390549.405	440571.395	203.830	Target
111T	390554.998	440575.668	204.117	Target
112T	390526.266	440618.762	205.560	Apex fence post
113T	390518.152	440624.042	205.750	Top right sign
114T	390525.445	440622.348	206.708	Top right white moulding
115T	390502.050	440609.886	204.983	Topr cnr barge board
116T	390509.568	440606.862	204.423	Top of fence post

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18 3

View location Weather: Mostly sunny Visibility: Good



Visualhorizon3D - Visually Verifiable Images: Views & Methodology





Methodology: Overview 4.00

- 4.1 The Visually Verifiable Images (VVIs), also know as Accurate Visual Representations (AVRs), created in this document are still images that show the proposed development in location and the degree to which it is (or is not) visible. VVIs are typically presented as either 'Wireline' outline views (Fig. 4.11 adjacent example) or fully rendered and detailed views (Fig. 4.12 adjacent example). Note. In the case of view location 2 a hybrid of both were shown for better understanding by the viewer.
- 4.2 A three dimensional computer model was accurately projected onto the base photographs to create the VVIs and the existing views are presented on adjacent pages for easy comparison.
- The location of the views in this instance were instructed by CPL ARCHITECTURE, 4.3 presumably after consultation with the relevant local authority and Professional consultants.
- 4.4 The original photographs were taken on 13/07/2022 and 10/08/2022, using a Nikon D610 camera with a full frame sensor, and it was decided that a standard 50mm lens would adequately capture all proposed views, as single frame images. A 50mm 1:1.8D AF Nikkor lens was used for all views.






Visualhorizon3D - Visually Verifiable Images: Views & Methodology

Figure 4.11

Figure 4.12

Methodology: Photography 5.00

- High resolution digital photography has been used (Fig. 5.11). Digital photography 5.1 is now very advanced, is fast, and holds all relevant data within the file needed to create the final view and output data for any possible future verification including camera type, lens used, time and date etc.
- All efforts are made to take the photographs in good, clear weather. 5.2
- 5.3 A location map (usually Ordnance Survey map or similar), descriptions and any available photographs are supplied to the photographer to easily find the view locations once on site.
- Each camera is set up level and directly over a surveyor pin (or fixed marker) that can 5.4 be accurately surveyed in the surveying process (described in the next section). A tribrach leveller¹ is used to accomplish this. The height of the lens is recorded by the photographer.
- RAW² format files are captured, thus ensuring full resolution, tonal range and colours 5.5 are recorded for latter use.
- The date and time is also recorded and should correspond to the date imbedded in 5.6 the digital photograph so that lighting conditions can be recreated in the corresponding 3D computer model. A photograph is taken of the marked location and tripod for future reference.
- Optical distortion is removed from the digital images to assist the camera matching 5.7 process.

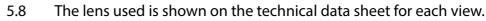



1

- A tribrach leveller allows accurate placement over the location as well as allowing levelling ability in the horizontal or vertical planes.
- 2 RAW format files contain the raw information captured by the camera sensor. The data captured is not yet processed so these files are the digital equivalent of a negative. Where the processing of on old style negative was done in a dark room, todays RAW image processing is done by computer software.

Visualhorizon3D - Visually Verifiable Images: Views & Methodology

6.00 Methodology: Surveying

- A professional measured building and land surveyor carries out the surveying work 6.1 for each view. The surveyor is supplied with a location map (usually Ordnance Survey map or similar), together with any other relevant location photos, to easily find the view locations once on site. Either the actual photograph to be used or an approved reconnaissance photograph is supplied for the surveyor to refer to.
- 6.2 The surveyor is supplied with an existing site survey. The surveyed points will be coordinated onto the existing site survey using traditional and accepted surveying methods. This is used later in the camera matching process (section 7.00). In some instances where the original site survey is on a local grid, Eastings and Northings may relate back to this.
- 6.3 For each view the camera location marker is surveyed and static points are recorded by the surveyor. The static points surveyed should be within the cameras field of view for each location. The points must be fixed, for example corners of buildings, fixed street furniture, corners of windows and edges of roads and these points are used to check horizontal and vertical alignment. Note. Views 5 to 10 were in existing fields so some marker poles³ were also banged into the ground to create temporary fixed points to survey.
- Electronic theodolite (Fig. 6.41) and reflectorless laser technology is used to locate 6.4 each static point and is to a tolerance of +/-5mm.
- The static points are numbered and all Eastings, Northings and levels Above Ordnance 6.5 Survey Datum (AOSD)⁴ information is recorded for each point. The points are marked and numbered on the approved photograph for each view (Fig. 6.51 example image). This image will then form the background plate in the 3D model file (see section 7.00). The surveyed information is supplied digitally to Visualhorizon3D in a combination of dwg⁵ and jpg⁶ formats as well as a text document with written descriptions for each point.





Figure 6.41


Figure 6.51

- There are occasions where a view will be in a field or in a location where some fixed points need to be created. In this instance markers poles are banged into the ground, the photograph is taken, the marker locations surveyed and later digitally removed from the photograph.
- 4 Eastings and Northings are geographic coordinates for a point from a datum. Above Ordnance Survey Datum refers to levels above a vertical datum. The origins for these datums are used by Ordnance Survey, the national mapping agency of Great Britain and measurements refer back to them. Where the original site survey is on a local grid, Eastings and Northing will relate back to this.
- 5 dwg is a file format used by many computer aided design packages to store 2D and 3D data.
- 6 Jpg is a digital image file format that can store and transmit photographic images.

7.00 Methodology: 3D Model & Camera matching

- 7.1 Unless an accurate 3D computer generated model⁸ is supplied, computer aided design (CAD) drawings are supplied (usually by the architect) often in dwg format. These would typically include a site survey, plans, elevations and sections explaining the construction and layout of the proposed development. In this instance, the architect supplied CAD drawings and an accurate 3D model⁸ was created, part of which can be seen in Fig. 7.11 (adjacent).
- 7.2 The 3D model was created in a 3D computer graphics software (3D software)⁷. In this instance, Autodesk 3ds Max. Heights and positioning are cross-checked against the supplied information. The 3D model is then accurately positioned over the supplied location/topographical plans and placed at the correct height location, as specified by the information supplied.
- 7.3 The surveyors information (see section 6.00) is then imported into the 3D software file and correctly overlaid on the location/topographical plans, ensuring all data is in the correct relationship.
- 7.4 (Refer to example Fig. 7.41 for the following description). The background plate is shown on screen in the 3D software and the virtual camera is located in the correct location and height (using the survey and photography information). The real world camera lens information is input to the corresponding virtual camera. The output image size is set to be identical to that of the background plate and, by adjusting the virtual camera target point, the surveyed points and corresponding background plate are accurately lined up. The process is double checked, and the same steps are followed for each virtual camera and background plate.
- 7.5 Locating the various elements and the camera matching process requires diligence and attention to detail. The 3D model now relates correctly to all surveyed points, cameras, site plan and background plates.
- 7.6 The 3D scene is now ready to be worked up to create two dimensional images for each camera location, the same size as the corresponding background plate (see section 8.00 for a description of this process).



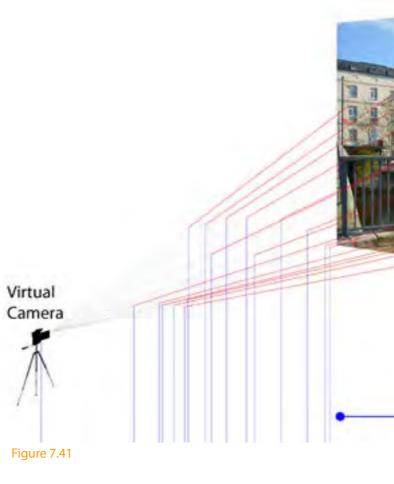

7

8

Figure 7.11

Visualhorizon3D - Visually Verifiable Images: Views & Methodology

Background plate with survey points marked

Surveyed points

3D computer graphics software is a computer programme that creates 3D computer generated imagery.

A 3D model is a mathematical representation of a three-dimensional object created using 3D software.

8.00 Methodology: Image creation and Post production

- 8.1 The camera matching and verification of size and location is an accurate procedure and can be audited. Lighting and texturing are created using both the expertise of the 3D artist and the input of the architect/designer. The existing photographs are examined to determine tonal and light behaviour at the time the photograph was taken. This assists in understanding how the scheme should appear within the final composition. The architect/designer should supply details of materials that will be used for the project and samples where possible.
- The 3D software has the ability to place a light representing the sun at the correct 8.2 orientation and time (as recorded in the digital photograph) to the accurately placed model. Any other real world lighting sources are recreated in the 3D scene using virtual lights. This is done for each camera location.
- 8.3 When the lighting and texturing⁹ are complete a 2D rendering¹⁰ of each image is generated by the 3D software ready to superimpose on the photograph.
- The rendered image and photograph of the existing view are both imported into 8.4 image editing software. Post-production¹¹ work is carefully and expertly carried out to edit, adjust and blend the two images together.
- 8.5 Due to the work carried out in the 3D model & Camera matching stage, the rendered image will accurately overlay on the existing photograph (Fig. 8.51 adjacent example).
- Any objects or parts of the photograph that will be in front/behind the proposed 8.6 development (Fig. 8.61 adjacent example) must be edited to show this scenario. There are different ways to achieve this but, suffice to say, the same end result is an image that shows the proposal correctly in place (Fig. 8.62 adjacent example).
- 8.7 The architect/designer is again consulted with regards material finishes. Any subtle amendments such as hue, saturation etc are made to give the end result.
- 8.8 This process is carried out for each view location required and the images are saved and output in a format relevant to the media they will be viewed in.







- 9 Texturing is the application of a surface to the 3D model. This can be done by wrapping 2D images or photographs on surfaces or by using software procedures and formulas to create the desired texture.
- 10 The process of creating a two dimensional image from a 3D model.
- 11 The final stage in production of a view.

Visualhorizon3D - Visually Verifiable Images: Views & Methodology



Figure 8.51

Figure 8.61



Figure 8.62



TAKEN FROM A SIMILAR VIEWPOINT AS VERIFIED VIEW 9 BUT THIS IS LOOKING EAST ALONG THE NEW SOUTHERN EDGE OF THE BUILT DEVELOPMENT. THE RETAINED DITCHLINE AND HAWTHORN TREES (WITH SOME ENHANCEMENT PLANTING) ARE CLEARLY SHOWN AS IS THE ENHANCED PLANTING TO THE EASTERN BOUNDARY

THIS TYPIFIES CHARACTER AREA 3 AS DESCRIBED IN THE DESIGN AND ACCESS STATEMENT BY CPL ARCHITECTURE



Rev. Date Details	Drawn Checked
PLANNING	
Project/Client.	Project No:
LAND TO EAST OF	2029
WINDERMERE AVE	Dwg No Rev
COLNE, PENDLE	3011
ACCRUE CAPITAL	Scale:
Accide cal line	NTS
Drawing.	North:
	Drawn By Date CPL 14.09.22
	Checked By Date CPL 14.09.22

CPL ARCHITECTURE



TAKEN FROM THE FOOTPATH RUNNING DOWN TO SKIPTON OLD ROAD ADJACENT TO THE PROPOSED CHILDRENS PLAY AREA WHICH IS SET INTO THE SLOPE SO IS NOT VISIBLE FROM THIS VIEWPOINT. THE WALKWAY ALONG THE NORTH SIDE OF THE NEW POND IS VISIBLE AS IS THE POND AND THE NEW COMMUNITY CAFE CREATED FROM THE REFURBISHED AND EXTENDED PUMP HOUSE.



Rev. Date Details	Drawn Checked	
PLANNING		
Project/Client	Project No:	
LAND TO EAST OF	2029	
WINDERMERE AVE	Dwg No Rev	
COLNE, PENDLE	3012	
ACCRUE CAPITAL	Scale:	
	NTS	
Drawing. INDICATIVE VIEW 12	North:	
	Drawn By Date	
	CPL 14.09.22	
	Checked By Date CPL 14.09.22	

CPL ARCHITECTURE



TAKEN FROM A THE PROPOSED MAIN ACCESS ROAD THROUGH THE DEVELOPMENT LOOKING NORTH TOWARDS THE CENTRAL SQUARE. THE SHARED SURFACE NATURE OF THE ROAD AND PATHS IS VISIBLE TOGETHER WITH THE CHARACTER OF THE DWELLINGS WHICH IS DRAWN FROM THE LOCAL VERNACULAR LANGUAGE OF MATERIALS, DETAILS AND FORM. IN THE DISTANCE, THE MOOLAND TO THE NORTH IS VISIBLE.

THIS VIEW IS TYPICAL OF CHARACTER AREA 2

Rev. Date Details	Drawn Checked	
PLANNING		
Project/Cilent	Project No.	
LAND TO EAST OF	2029	
WINDERMERE AVE	Dwg No Rev	
COLNE, PENDLE	3013	
ACCRUE CAPITAL	Scale:	
	NTS	
Drawing.	North:	
	Drawn By Date CPL 14.09.22	
	Checked By Date CPL 14.09.22	

CPL ARCHITECTURE



TAKEN FROM A THE PROPOSED MAIN ACCESS ROAD THROUGH THE DEVELOPMENT LOOKING SOUTH INTO THE CENTRAL SQUARE. THE SHARED SURFACE NATURE OF THE ROAD AND PATHS IS VISIBLE TOGETHER WITH THE CHARACTER OF THE DWELLINGS WHICH IS DRAWN FROM THE LOCAL VERNACULAR LANGUAGE OF MATERIALS, DETAILS AND FORM. IN THE DISTANCE, THE MOOLAND TO THE SOUTH IS VISIBLE.

THIS TYPICAL OF THE CHARACTER AREA 1 AS DESCRIBED IN THE DESIGN AND ACCESS STATEMENT BY CPL ARCHITECTURE

Rev. Date Details	Drawn Checked
PLANNING	
Project/Client	Project No: 2029
WINDERMERE AVE	Dwg No: Rev
COLNE, PENDLE	3014
ACCRUE CAPITAL	NTS
Drawing.	North:
	Drawn By Date CPL 14.09.22
	Checked By Date CPL 14.09.22

CPL ARCHITECTURE

CHRIS LITTLEMORE BA(Hons) BArch MSc RIBA CHARTERED ARCHITECT

MEADOW HOUSE BROAD CHALKE SALISBURY SP5 5HA T: 01722 760120 · M 07715 486611 E: chris@cplarchitecture.com www.cplarchitecture.com



TAKEN FROM A THE NORTHERN END OF THE PROPOSED MAIN ACCESS ROAD LOOKING SOUTH. THIS AND THE CENTRAL SQUARE ARE THE DENSEST PARTS OF THE DEVELOPMENT DRAWING THEIR CHARACTER FROM LOCAL SETTLEMENTS IN TERMS OF HOUSE FORM, DETAIL AND MATERIALS.

THE ORGANIC LINEAR NATURE OF THE STREET TYPIFIES CHARACTER AREA 2 AS DESCRIBED IN CPL ARCHITECTURE DESIGN AND ACCESS STATEMENT

Project No:
2029
Dwg No: Rev
3015
Scale:
NTS
North:
Drawn By Date
CPL 14.09.22
Checked By Date CPL 14.09.22

CPL ARCHITECTURE





VERIFIED VIEW 1 - EXISTING

LOOKING UP SKIPTON OLD ROAD EXISTING DERELICT PUMP HOUSE VISIBLE NONE OF THE DEVELOPMENT SITE BEYOND PUMP HOUSE IS VISIBLE

VERIFIED VIEW 1 - PROPOSED

RENOVATED AND EXTENDED PUMP HOUSE CAFE IS VISIBLE

NO OTHER PROPOSED IS VISIBLE FROM THIS VIEWPOINT



Rev. Date Details	Drawn Checked	
PLANNING		
Project/Client	Project No	
LAND TO EAST OF	2029	
WINDERMERE AVE	Dwg No Rev	
COLNE, PENDLE	3001	
ACCRUE CAPITAL	Scale:	
	NTS	
Drawing. KEY VERIFIED VIEW 1	North:	
	Drawn By Date CPL 14.09.22	
	Checked By Date CPL 14.09.22	

CPL ARCHITECTURE

CHRIS LITTLEMORE BA(Hons) BArch MSc RIBA CHARTERED ARCHITECT

MEADOW HOUSE BROAD CHALKE SALISBURY SP5 5HA T: 01722 760120 : M 07715 486611 E: chris@cplanchReture.com www.cplarchitecture.com



VERIFIED VIEW 2 - EXISTING

FROM SKIPTON OLD ROAD LOOKING NORTH NORTH EAST INTO THE SITE AT THE START OF THE UNMADE FOOTPATH WHICH CROSSES THE SITE



VERIFIED VIEW 2 - PROPOSED

ONE VERY SMALL ROOF RIDGE AND CHIMNEY ARE VISIBLE ALL OTHER DEVELOPMENT IS SCREENED OR OUT OF SIGHT FROM THIS VIEW.

THE PROFILE OF PROPOSED ROOFSCAPE IS SHOWN WITH A RED DASHED LINE



Rev. Date Details	Drawn Checked
PLANNING	
Project/Client	Project No:
LAND TO EAST OF	2029
WINDERMERE AVE	Dwg No Rev
COLNE, PENDLE	3002 Scale:
ACCRUE CAPITAL	NTS
Drawing: KEY VERIFIED VIEW 2	North:
	Drawn By Date
	CPL 14.09.22
	Checked By Date: CPL 14.09.22

CPL ARCHITECTURE

CHRIS LITTLEMORE BA(Hons) BArch MSc RIBA CHARTERED ARCHITECT

MEADOW HOUSE BROAD CHALKE SALISBURY SP5 5HA T. 0722 780120 - M 07715 486611 E chris@planchReture.com www.cplarchitecture.com



VERIFIED VIEW 3 - EXISTING

ON SKIPTON OLD ROAD LOOKING SOUTH WEST DOWN THE HILL.

VERIFIED VIEW 3 - PROPOSED

THERE IS NO EXTENT OF THE PROPOSED DEVELOPMENT VISIBLE IN THIS VIEW





Rev. Date Details	Details Drawn Checked	
PLANNING		
Project/Client.	Project No:	
LAND TO EAST OF	2029	
WINDERMERE AVE	Dwg No Rev	
COLNE, PENDLE	3003	
ACCRUE CAPITAL	Scale:	
	NTS	
KEY VERIFIED VIEW 3	North:	
KET VERIFIED VIEW 3	CPL 14.09.22	
	Checked By Date CPL 14.09.22	

CPL ARCHITECTURE





ON SKIPTON OLD ROAD LOOKING SOUTH WEST DOWN THE HILL.



THERE IS NO EXTENT OF THE PROPOSED DEVELOPMENT VISIBLE IN THIS VIEW





Rev. Date Details	e Detais Drawn Checked	
PLANNING		
Project/Cilent	Project No:	
LAND TO EAST OF	2029	
WINDERMERE AVE	Dwg No Rev	
COLNE, PENDLE	3004	
ACCRUE CAPITAL	Scale:	
	NTS	
KEY VERIFIED VIEW 4	North:	
KET VERIFIED VIEW 4	CPL 14.09.22	
	Checked By Date CPL 14.09.22	

CPL ARCHITECTURE



VERIFIED VIEW 5 - EXISTING

TAKEN FROM CENTRE OF OPEN GRASS AT LOWER END OF SITE IN A LOCATION WHERE THERE IS A POTENTIAL DESIRE LINE FOR PEDESTRIANS TO CROSS BETWEEN THE TWO UNMADE FOOTPATHS RUNNING NORTH-SOUTH AND NORTH-WEST TO SOUTH-EAST. THE DERELICT PUMP HOUSE IS VISIBLE AS ARE THE **NEW DWELLINGS BUILT IN THE CONSERVATION** AREA ON THE LAND IMMEDIATELY TO THE WEST OF THE PROPOSED DEVELOPMENT SITE BY **MCDERMOTT HOMES**



VERIFIED VIEW 5 - PROPOSED

THE PROPOSED VIEW FROM THIS LOCATION SHOWS THE REFURBISHED AND EXTENED PUMP HOUSE IN ITS **PROPOSED USE AS A COMMUNITY CAFE** NEW TREE PLANTING SOFTENS THE IMPACT OF THE MCDERMOTT DEVELOPMENT. THERE IS A SOFT FINISHED PATH (HOGGIN) CONNECTING THE TWO MAIN PEDESTRIAN ROUTES WHICH CROSS THE SITE AS DESCRIBED ABOVE. THIS PATH LINKS TO THE NEW COMMUNITY CAFE AND ALSO PROVIDES THE POTENTIAL FOR A PEDESTRIAN LINK INTO THE MCDERMOTT HOMES DEVELOPMENT WHERE NONE EXISTS AT PRESENT.



Rev. Date Details Issued for	Drawn Checked
PLANNING	
Project/Client.	Project No:
LAND TO EAST OF	2029
WINDERMERE AVE	Dwg No Rev
COLNE, PENDLE	3005
ACCRUE CAPITAL	Scale:
	NTS
Drawing.	North:
KEY VERIFIED VIEW 5	Drawn By Date CPL 14.09.22
	Checked By Date CPL 14.09.22

CPL ARCHITECTURE





TAKEN FROM THE POINT ON THE EXISTING UNMADE FOOTPATH CROSSING THE SITE FROM NORTH-WEST TO SOUTH EAST, WHERE THE LAND STARTS TO DROP TOWARDS THE HOUSES BUILT ON THE NORTH SIDE OF SKIPTON OLD ROAD IN THE SOUTH-EAST CORNER OF THE SITE.



VERIFIED VIEW 6 - PROPOSED

THE PROPOSED VIEW FROM THIS LOCATION SHOWS THE NEW SOFT FINISHED FOOTPATH (HOGGIN) TO PROVIDE A BETTER LINE OF CONNECTIVITY BETWEEN SKIPTON OLD ROAD AND CASTLE ROAD TO THE NORTH. SOME ADDITIONAL ENHANCED TREE PLANTING IS ALSO SHOWN. THERE IS NO OTHER CHANGE FROM THIS VIEWPOINT.





Project No:
Project No.
2029
Dwg No Rev
3006
Scale:
NTS
North:
Drawn By Date CPL 14.09.22
Checked By Date CPL 14.09.22

CPL ARCHITECTURE



VERIFIED VIEW 7 - EXISTING

TAKEN FROM THE POINT IN A CENTRAL LOCATION ON THE SITE WHERE THERE IS NO UNMADE PATH OR OTHER IMPLIED ROUTE. THIS IS AROUND 18M TO THE NORTH OF A LINE OF EXISTING LOW HAWTHORN TREES AND **DITCH-LINE WHICH IS TO BE RETAINED.** THE GAP IN THIS DITCH-LINE OFFERS A VIEW OVER THE CONSERVATION AREA AND TO THE MOORLAND BEYOND.



VERIFIED VIEW 7 - PROPOSED

THE PROPOSED VIEW FROM THIS LOCATION SHOWS NO MATERIAL CHANGE OTHER THAN THE PRESENCE OF SOME TREE PLANTING TO THE SOUTH-EAST CORNER OF THE SITE AND PLANTING TO ENHANCE THE LINE OF TREES AT THE SOUTHERN **BOUNDARY OF THE SITE.**



Rev. Date Details	Date Details Drawn Checked	
PLANNING		
Project/Client	Project No: 2029	
WINDERMERE AVE COLNE, PENDLE	Dwg No Rev 3007	
ACCRUE CAPITAL	Scale: NTS	
Drawing.	North:	
KEY VERIFIED VIEW 7	Drawn By Date CPL 14.09.22	
	Checked By Date CPL 14.09.22	

CPL ARCHITECTURE





VERIFIED VIEW 8 - EXISTING

TAKEN FROM THE HIGHEST POINT ON THE EXISTING UNMADE FOOTPATH RUNNING FROM NORTH-WEST TO SOUTH-EAST ACROSS THE SITE. THIS VIEW AFFORDS A VIEW ACROSS THE CONSERVATION AREA LOOKING SOUTH-EAST.

VERIFIED VIEW 8 - PROPOSED

THE PROPOSED VIEW FROM THIS LOCATION SHOWS THE END OF THE SHARED SURFACE PRIVATE DRIVE SERVING PLOT NO 147 WHERE THE DRIVE NARROWS TO CONTINUE AS A FOOTPATH RUNNING TOWARDS SKIPTON OLD ROAD ON THE LINE OF THE EXISTING UNMADE PATH.

NO MATERIAL CHANGE EXISTS OTHER THAN THE INTRODUCTION OF A SUDS DRAINAGE DITCH IN THE FOREGROUND AND THE PRESENCE OF SOME TREE PLANTING TO THE SOUTH-EAST CORNER OF THE SITE AND PLANTING TO ENHANCE THE LINE OF TREES ON THE SOUTHERN BOUNDARY.



Date Details Drawn Checked	
Project No	
2029	
Dwg No Rev	
3008	
Scale:	
NTS	
North:	
Drawn By Date CPL 14.09.22	
Checked By Date CPL 14.09.22	

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VERIFIED VIEW 9 - EXISTING

TAKEN FROM THE POINT ON THE EXISTING UNMADE FOOTPATH RUNNING FROM NORTH TO SOUTH ACROSS THE SITE WHERE THE VIEW OVER THE CONSERVATION AREA APPEARS FROM **BEHIND THE NEW HOUSING DEVELOPMENT** BY MCDERMOTT HOMES. THIS IS WHERE THE PATH **ROUTE CROSSES THROUGH A DITCH LINE** AND HEADS DIRECTLY DOWN TO SKIPTON OLD ROAD. THE EXISTING DERELICT PUMP HOUSE

IS CLEARLY SEEN.



VERIFIED VIEW 9 - PROPOSED

THE PROPOSED VIEW FROM THIS LOCATION SHOWS THE EXTENDED REFURBISHED PUMP HOUSE WHICH BECOMES A COMMUNITY CAFE AS PART OF THE PROPOSALS. THERE IS A PROPOSED PRIVATE SHARED SURFACE ACCESS TO THE CAFE FOR ACCESSIBLE PARKING AND THE OCCASIONAL DELIVERY. THIS ROUTE ALSO ACTS AS THE CONTINUATION OF THE LINE OF THE EXISTING PUBLIC RIGHT OF WAY FOOTPATH RUNNING FROM CASTLE ROAD IN THE NORTH DOWN TO SKIPTON OLD ROAD. THIS ROUTE CAN ALSO ACT AS A CYCLE ROUTE TO LINK CASTLE ROAD WITH SKIPTON OLD ROAD.



Rev. Date Details	Drawn Checked
PLANNING	
Project/Client	Project No:
LAND TO EAST OF	2029
WINDERMERE AVE	Dwg No Rev
COLNE, PENDLE	3009
ACCRUE CAPITAL	Scale:
	NTS
Drawing.	North:
KEY VERIFIED VIEW 9	Drawn By Date
	CPL 14.09.22
	Checked By Date CPL 14.09.22

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VERIFIED VIEW 10 - EXISTING

TAKEN FROM A DISTANT FOOTPATH TO THE SOUTH EAST OF THE SITE ON THE SOUTH SIDE OF SKIPTON OLD ROAD AND WITHIN THE CONSERVATION AREA. THIS UNMADE FOOTPATH RUNS EAST TO WEST AND THERE IS A GLIMPSE VIEW OF THE UPPER PARTS OF THE PROPOSED DEVELOPMENT SITE.

THIS VIEW IS FRAMED BY THE EXISTING DWELLINGS ON THE SOUTH SIDE OF SKIPTON OLD ROAD AND HAS VARIOUS TREES WITHIN THE SETTING.



VERIFIED VIEW 10 - PROPOSED

THE PROPOSED VIEW FROM THIS LOCATION SHOWS DISTANT ROOFSCAPE OF THE PROPOSED DEVELOPMENT ALONGSIDE ADDITIONAL TREES TO BE PLANTED AS PART OF THE PROPOSALS. THE ROOFSCAPE FOLLOWS THE LINE OF THE DISTANT HORIZON WITH THE IMPACT BEING MINIMAL AND OF NO MATERIAL HARM TO THE SETTING OR APPEARANCE OF THE CONSERVATION AREA.



Rev. Date Details	Drawn Checked
PLANNING	
Project/Client	Project No
LAND TO EAST OF	2029
WINDERMERE AVE	Dwg No Rev
COLNE, PENDLE	3010
ACCRUE CAPITAL	Scale:
ACCIDE CALITAL	NTS
Drawing: KEY VERIFIED VIEW 10	North:
KEY VERIFIED VIEW 10	Drawn By Date CPL 14.09.22
	Checked By Date CPL 14.09.22

CPL ARCHITECTURE

CHRIS LITTLEMORE BA(Hons) BArch MSc RIBA CHARTERED ARCHITECT

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(11111)

Proposed Local Equipped Area for Play ------(LEAP)

Proposed Amenity Grass to Residential Areas, Shrub and Front Garden hedges









where appropriate

Proposed Road Layout For surfacing refer to Architectural and Drainage Information

Recent Development



client

Accrue Capital

project title

Colne, Pendle

drawing title

Landscape Strategy

date	21 SEPTEMBER 2022	drawn by	GYo
drawing number	edp7440_d008d	checked	DRo
scale	1:1,500 @ A2	QA	JFr

dimension partnership

Registered office: 01285 740427 - www.edp-uk.co.uk - info@edp-uk.co.uk



Existing Vegetation to be Retained

Existing Seasonally Wet Ditch

Existing Semi-improved Neutral Grassland to be enhanced with an appropriate Wildflower Mix

Existing Marshy Grassland to be enhanced with appropriate Tussock and Wildflower Mix

Existing Gaps within Hedgerows to be filled with native species of localprovidence to increase species diversity and provide ecological benefits

Proposed Trees

- Proposed Native Structural Planting
- Proposed Swale/Detention Areas
- Proposed Pond

Proposed Wetland and Marginal Planting

- Proposed Mown Path
- Proposed Footpath
- Pedestrian Access
- Vehicular Access













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Photoviewpoints

(edp7440_d006b 31 January 2022 GY/DR)

Photoviewpoint EDP 1	View from Skipton Old Road looking north towards the site
Photoviewpoint EDP 2	From Windermere Avenue looking east towards the site
Photoviewpoint EDP 3	View from Castle Road looking south-east towards the site
Photoviewpoint EDP 4	View from Cockhill Lane looking west towards the site
Photoviewpoint EDP 5	View from PRoW 13-12-FP 39 (to the south of Noya Lane) looking south towards the site
Photoviewpoint EDP 6	View from Colne Football Club looking east towards the site
Photoviewpoint EDP 7	View from PRoW 13-7-FP 32 (to the west of Mile Ridge) looking north towards the site. Viewpoint 14 identified within the Colne Significant View Assessment
Photoviewpoint EDP 8	View from PRoW 13-6-FP 185 (to the north of Back Lane) looking north towards the site
Photoviewpoint EDP 9	View from PRoW 13-4 139 within the site looking towards Tum Hill and Lenches located to the south-west. Viewpoint 11 identified within the Colne Significant View Assessment
Photoviewpoint EDP 10	View from PRoW 13-4 189 within the Lenches looking north towards the site. Viewpoint 16 identified within the Colne Significant View Assessment
Photoviewpoint EDP 11	View from PRoW 13-6 130 within Tum Hill looking north-east towards the site. Viewpoint 17 identified within the Colne Significant View Assessment
Photoviewpoint EDP 12	View from PRoW 13-4 20 looking south-west towards the site. Viewpoint Location 1 identified within the appeal submission
Photoviewpoint EDP 13	View from PRoW 13-475 looking south-west towards the site. Viewpoint Location 2 identified within the appeal submission
Photoviewpoint EDP 14	View from Pennine Bridleway looking south-west towards the site. Viewpoint Location 3 identified within the appeal submission
Photoviewpoint EDP 15	View from Pendle Way looking south-west towards the site. Viewpoint Location 4 identified within the appeal submission

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Grid Coordinates: 390329, 440511 Horizontal Field of View: 90° the environmental dimension partnership dimension partnership Visualisation Type: 1

 Make, Model, Sensor:
 Canon 5D MK2, FFS
 aOD:
 190m

 Enlargement Factor:
 96% @ A1 width
 Focal Length:
 50mm

Direction of View: 5° Distance: 10m

<u>e(</u>

date**31 JANUARY 2022**drawing numberedp7440_d006bdrawn byGYcheckedDRQARB Accrue Capital client project title Colne, Pendle drawing title **Photoviewpoint EDP 1**



the environmental

Registered office: 01285 740427 dimension partnership

Grid Coordinates: 390045, 440690 Date and Time: 17/11/2021@12 Projection: Planar Visualisation Type: 1

0	Horizontal Field of View:	39.6°
12:29	Height of Camera:	1.6 m
	Make, Model, Sensor:	Canon
	Enlargement Factor:	100%

39.6°	Direction of View:	75°
1.6m	Distance:	65m
Canon 5D MK2, FFS	aOD:	197m
100% @ A3	Focal Length:	50mm

n m	date drawing number drawn by checked OA	31 JANUARY 2022 edp7440_d006b GY DR RB

client project title Colne, Pendle drawing title Photoviewpoint EDP 2

Accrue Capital



Grid Coordinates: 390031, 440987 Horizontal Field of View: 90° the environmental dimension partnership dimension partnership Visualisation Type: 1

 Make, Model, Sensor:
 Canon 5D MK2, FFS
 aOD:
 207m

 Enlargement Factor:
 96% @ A1 width
 Focal Length:
 50mm

Direction of View: 85° Distance: 85m

600

	date drawing number	31 JANUARY 2022 edp7440 d006b	client	Accrue Capital
	drawn by	GY	project title	Colne, Pendle
н	checked QA	DR RB	drawing title	Photoviewpoint EDP 3





Visualisation Type: 1

Direction of View: **245**° Distance: **660m**

 Make, Model, Sensor:
 Canon 5D MK2, FFS
 aOD:
 217m

 Enlargement Factor:
 96% @ A1 width
 Focal Length:
 50mm

late Irawing number	31 JANUARY 2022 edp7440 d006b	client	Accrue Capital
Irawn by hecked	GY DR	project title	Colne, Pendle
jA		drawing title	Photoviewpoint EDP 4



Approximate extent of site - Views of the site limited by the intervening topography and vegetation

> Residential properties on Castle Road to the north of the site boundary

Park High School



Registered office: 01285 740427 the environmental www.edp-uk.co.uk info@edp-uk.co.uk dimension partnership

Grid Coordinates: 390553, Date and Time: 17/11/20 Projection: Planar Visualisation Type: 1

442369	Horizontal Field of		
2021 @ 13:06	Height of Camera:		
	Make, Model, Sens		
	Enlargement Facto		

f View: 39.6° **1.6**m sor: Canon 5D MK2, FFS aOD: tor: 100% @ A3

Direction of View: 195° Distance: Focal Length:

date31 JANUARY 2022drawing numberedp7440_d006bdrawn byGYcheckedDRQARB 135m 240m 50mm

client project title Colne, Pendle drawing title Photoviewpoint EDP 5



Accrue Capital



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Registered office: 01285 740427 dimension partnership www.edp-uk.co.uk

Grid Coordinates: 388246, 440822 Date and Time: 17/11/2021 @ 16:45 Height of Camera: Projection: Planar Visualisation Type: 1

Horizontal Field of View: 39.6° Make, Model, Sensor: Enlargement Factor:


03.0	Direction of v
1.6m	Distance:
Canon 5D MK2, FFS	a0D:
100% @ A3	Focal Length:

Direction of View: Distance: aOD:	90° 1.80km 198m	date drawing num drawn by checked
Focal Length:	50mm	QA checked

client project title Colne, Pendle

C

Accrue Capital drawing title Photoviewpoint EDP 6

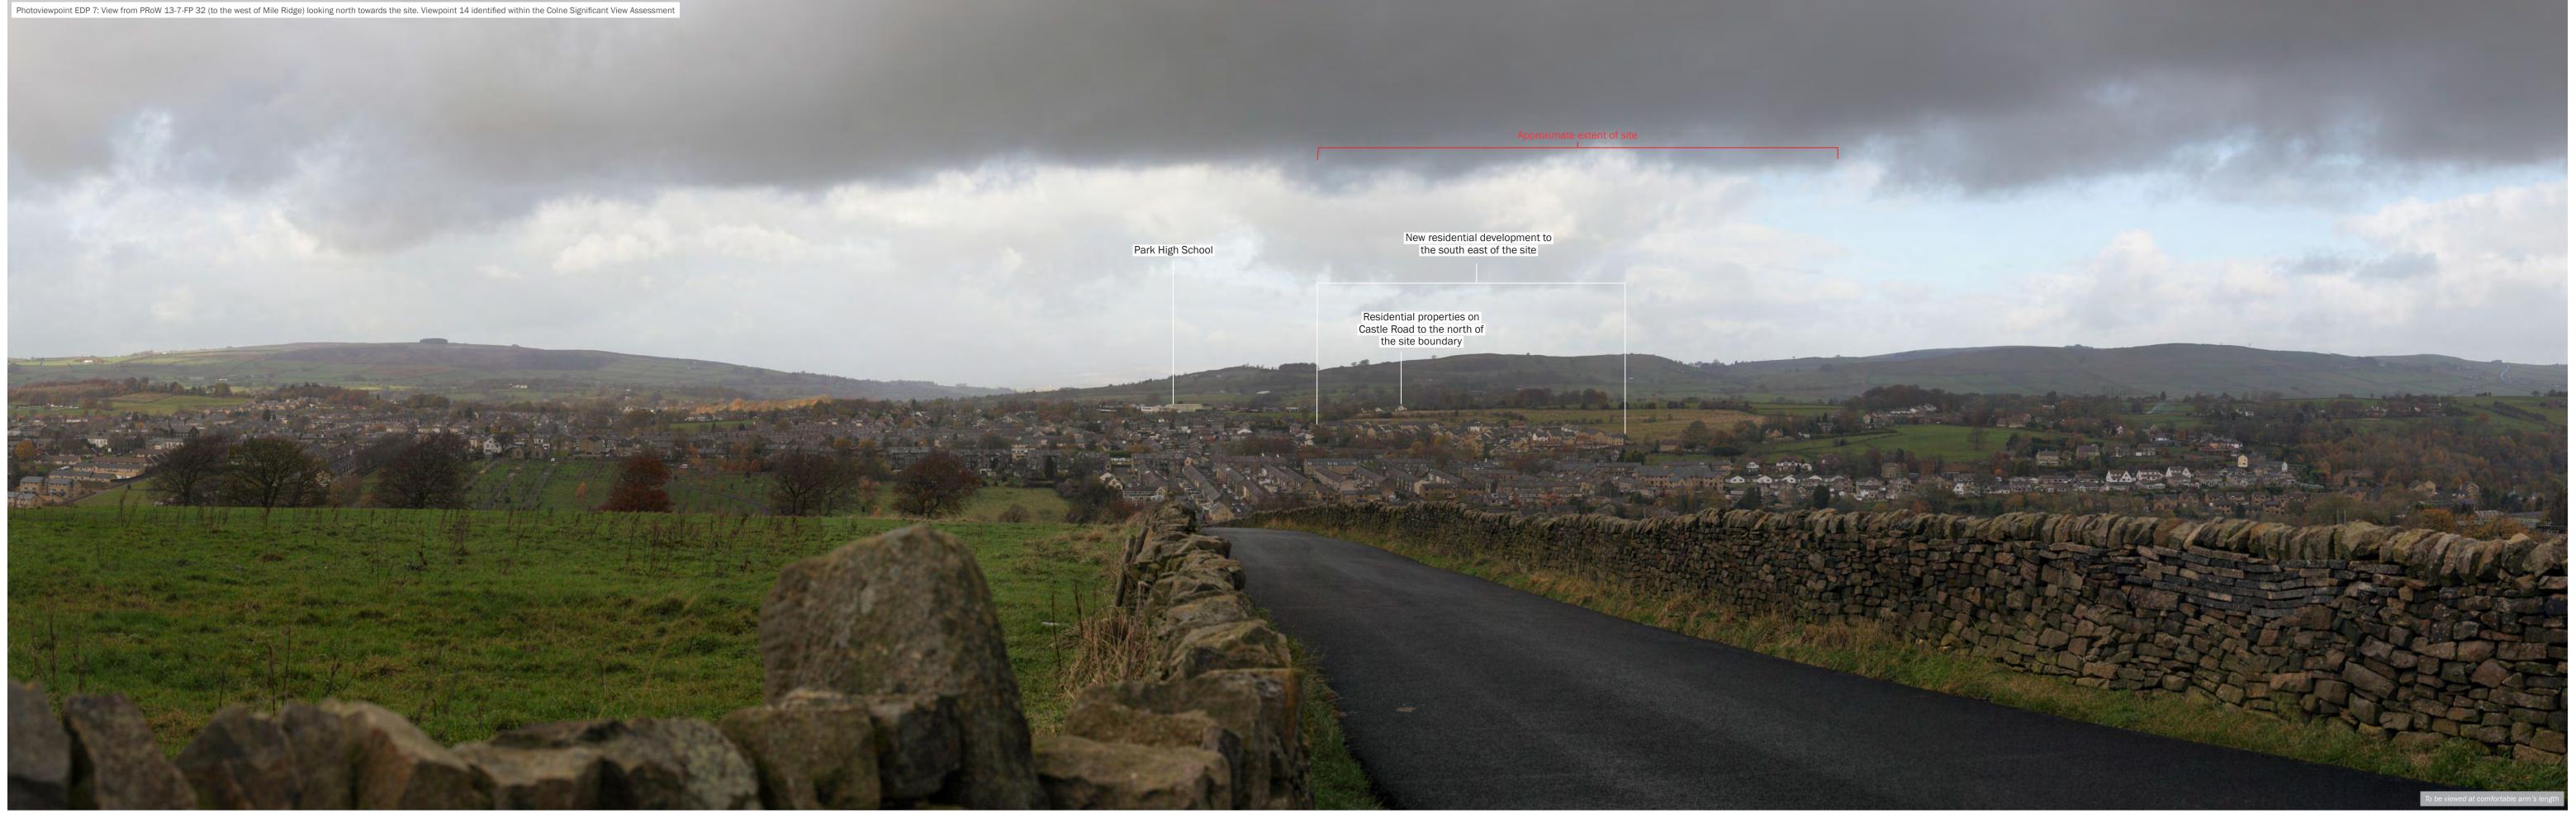

ne environmental imension partnership

Grid Coordinates: 390199, 439320 Horizontal Field of View: 90°

 Registered office: 01285 740427
 Grid Coordinates: 390199, 439320
 Horizontal Field of View: 90*

 www.edp-uk.co.uk
 Date and Time: 17/11/2021@13:42
 Height of Camera: 1.6m

 Projection:
 Cylindrical
 Make, Model, Sensor: Canon 5

 Wurdip-uk.co.uk
 Projection: Cylindrical
 Make, Model, Sensor: Canon 5

 Visualisation Type: 1

 Height of Camera:
 1.6m
 Distance:
 1.22km

 Make, Model, Sensor:
 Canon 5D MK2, FFS
 aOD:
 233m

 Enlargement Factor:
 96% @ A1 width
 Focal Length:
 50mm

Direction of View: 5°

C

date drawing number	31 JANUARY 2022 edp7440_d006b	client	Accrue Capital
drawn by checked	GY DR	project title	Colne, Pendle
QA	RB	drawing title	Photoviewpoint EDP 7



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Date and Time: 17/11/2021 @ 14:51 Projection: Planar Visualisation Type: 1

Horizontal Field of View:	39.6°
Height of Camera:	1.6m
Make, Model, Sensor:	Canon 5D MI
Enlargement Factor:	100% @ A3

/10	Direction of field.	
6m	Distance:	2.98km
anon 5D MK2, FFS	aOD:	309m
00% @ A3	Focal Length:	50mm

	date	31 JANUAR
	drawing number	edp7440_d
	drawn by	GY
	checked	DR
l	QA	RB

project title Colne, Pendle drawing title Photoviewpoint EDP 8



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 Grid Coordinates:
 390183, 440885

 Date and Time:
 17/01/2022 @ 16:02

 Projection:
 Planar

 Visualisation Type:
 1


	Horizontal Field of View:	39.6°	Direction of View:
02	Height of Camera:	1.6m	Distance:
	Make, Model, Sensor:	Canon 5D MK2, FFS	aOD:
	Enlargement Factor:	100% @ A3	Focal Length:

v:	20° 0m 209m 50mm	date drawing number drawn by checked OA	31 JANUARY 2022 edp7440_d006b GY DR RB	client project title drawing tit
	SOUUL	U QA	RB	urawing ut

Accrue Capital tle Colne, Pendle title Photoviewpoint EDP 9




MEADOW HOUSE BROAD CHALKE SALISBURY SP5 SHA T: 01722 780120 : M 07715 486611 E: chris@cplarchitecture.com www.cplarchitecture.com e crt.ARCHTECTURE.LTD Contractors mat ware vis bis y bis divedent on the bis divedent on the bis divedent on the bis divedent on the

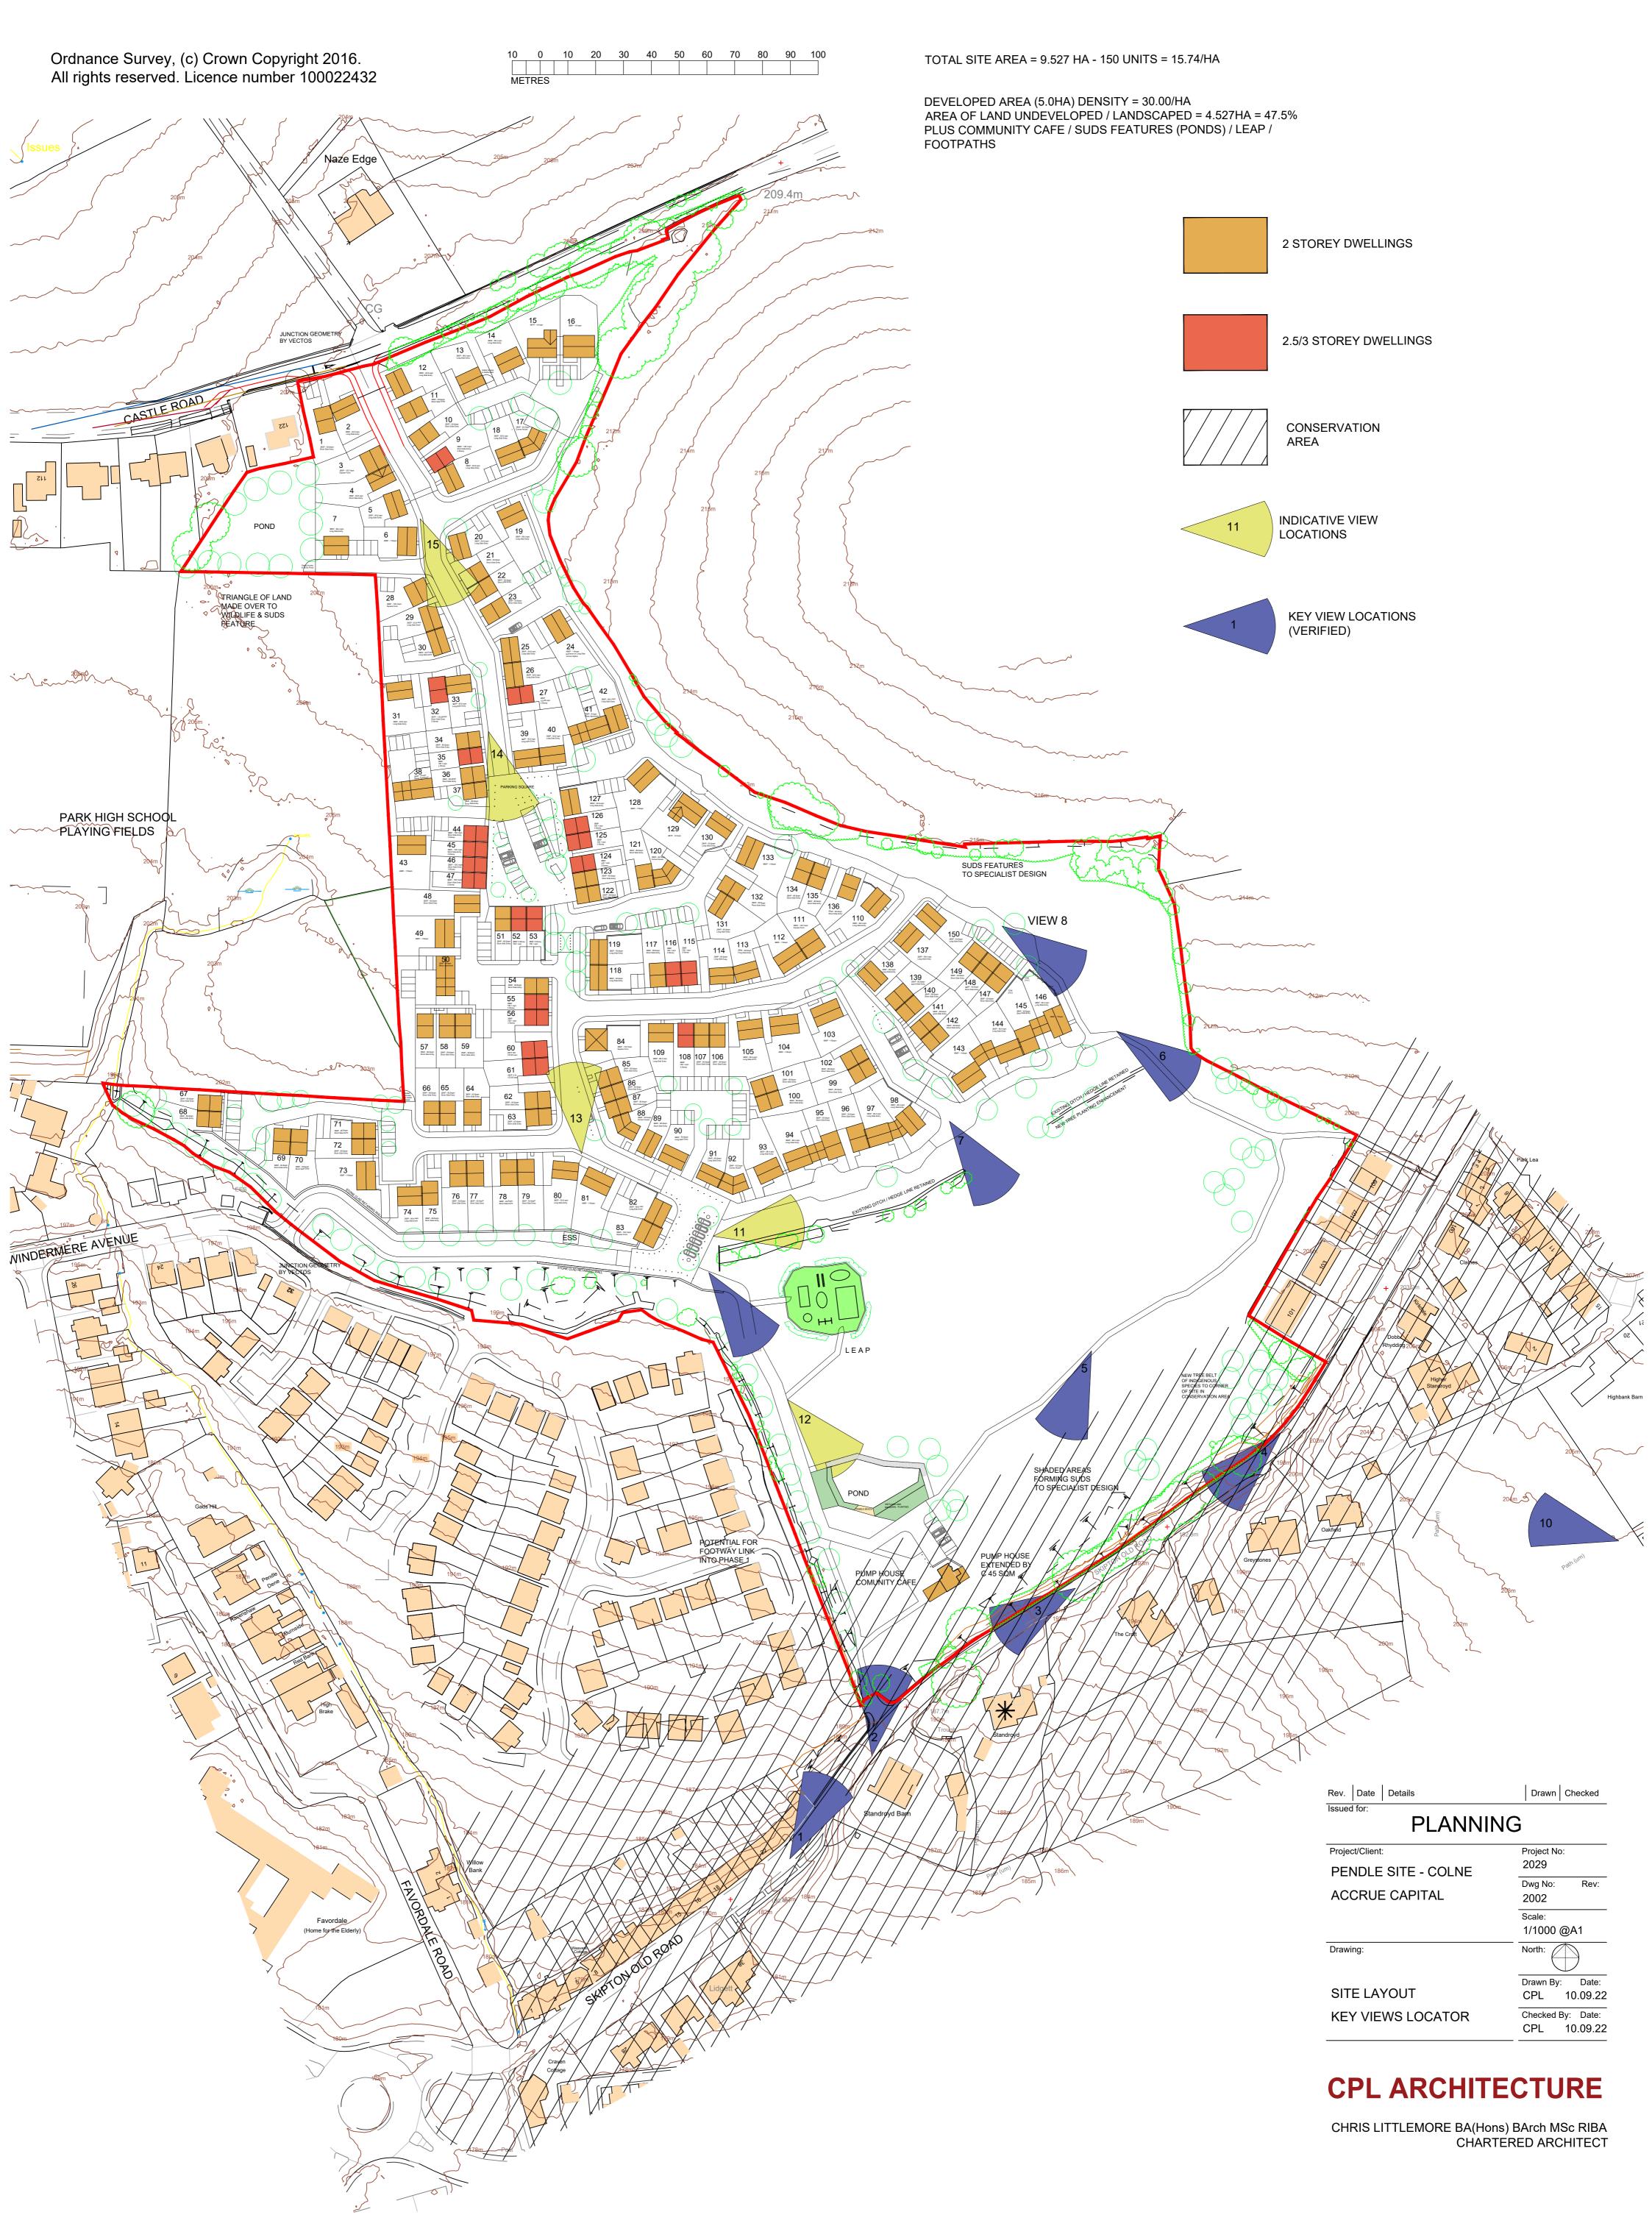

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PROVIDES THE POTENTIAL FOR A PEDESTRIAN LINK INTO THE MCDERMOTT HOMES DEVELOPMENT WHERE NONE EXISTS AT PRESENT.

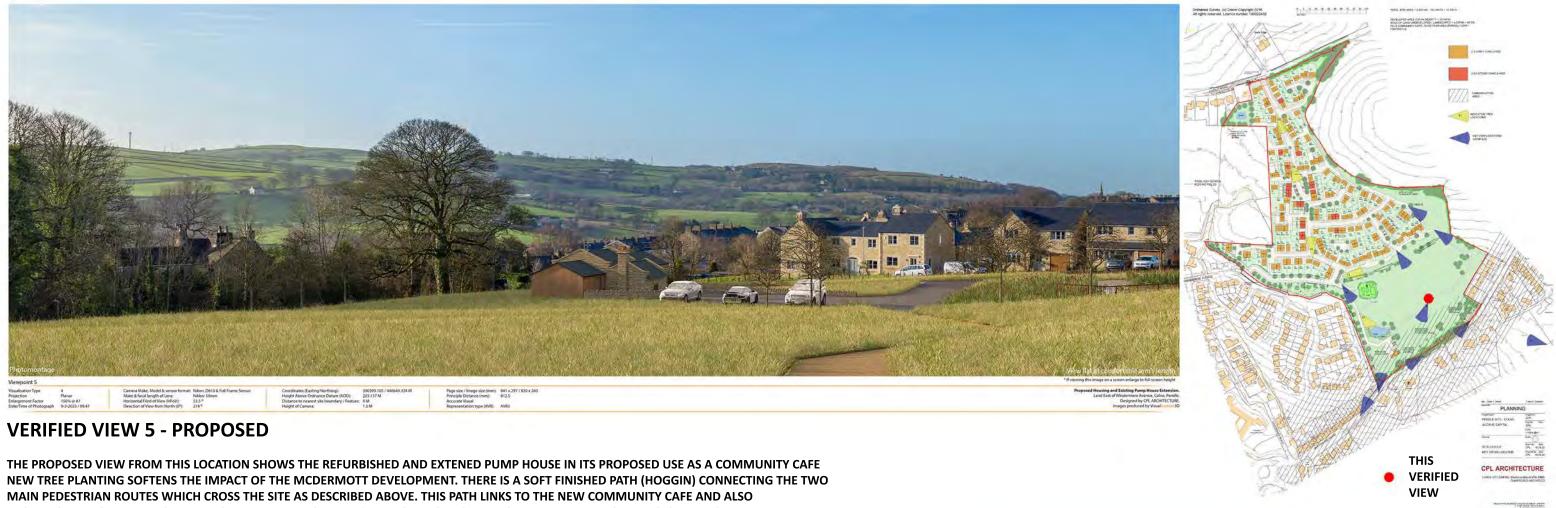

VERIFIED VIEW 5 - EXISTING


Nikkor 90.0 214.9

ylindrical 6% @ A1

TAKEN FROM CENTRE OF OPEN GRASS AT LOWER END OF SITE IN A LOCATION WHERE THERE IS A POTENTIAL DESIRE LINE FOR PEDESTRIANS TO CROSS BETWEEN THE TWO UNMADE FOOTPATHS RUNNING NORTH-SOUTH AND NORTH-WEST TO SOUTH-EAST. THE DERELICT PUMP HOUSE IS VISIBLE AS ARE THE NEW DWELLINGS BUILT IN THE CONSERVATION AREA ON THE LAND IMMEDIATELY TO THE WEST OF THE PROPOSED DEVELOPMENT SITE BY MCDERMOTT HOMES

Rev. Date Details	Drawn Checked
PLANNING	
Project/Client	Project No: 2029
LAND TO EAST OF WINDERMERE AVE	Dwg No Rev
COLNE, PENDLE ACCRUE CAPITAL	4005 Scale
	NTS
Drawing: KEY VERIFIED WINTER VIEW 5	North:
	Drawn By Date CPL 14.09.22
	Checked By Date CPL 14.09.22

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PROVIDES THE POTENTIAL FOR A PEDESTRIAN LINK INTO THE MCDERMOTT HOMES DEVELOPMENT WHERE NONE EXISTS AT PRESENT.

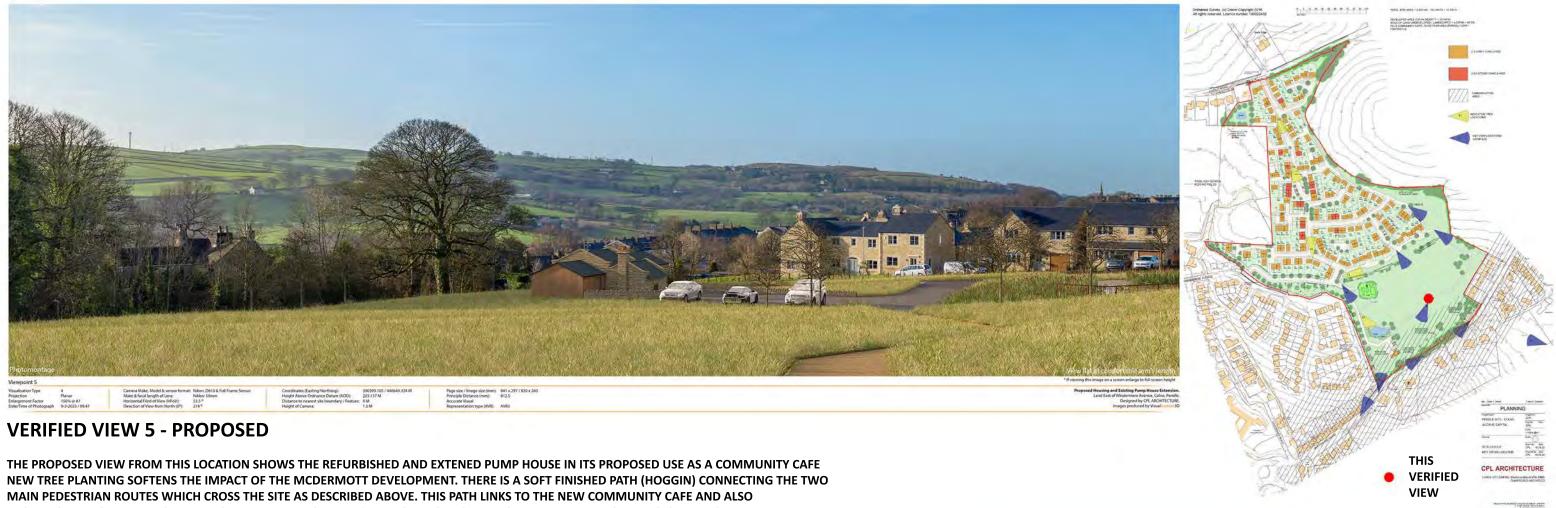

VERIFIED VIEW 5 - EXISTING

Nikkor 90.0 214.9

ylindrical 6% @ A1

TAKEN FROM CENTRE OF OPEN GRASS AT LOWER END OF SITE IN A LOCATION WHERE THERE IS A POTENTIAL DESIRE LINE FOR PEDESTRIANS TO CROSS BETWEEN THE TWO UNMADE FOOTPATHS RUNNING NORTH-SOUTH AND NORTH-WEST TO SOUTH-EAST. THE DERELICT PUMP HOUSE IS VISIBLE AS ARE THE NEW DWELLINGS BUILT IN THE CONSERVATION AREA ON THE LAND IMMEDIATELY TO THE WEST OF THE PROPOSED DEVELOPMENT SITE BY MCDERMOTT HOMES

Rev. Date Details	Drawn Checked
PLANNING	
Project/Client	Project No: 2029
LAND TO EAST OF WINDERMERE AVE	Dwg No Rev
COLNE, PENDLE ACCRUE CAPITAL	4005 Scale
	NTS
Drawing: KEY VERIFIED WINTER VIEW 5	North:
	Drawn By Date CPL 14.09.22
	Checked By Date CPL 14.09.22

CPL ARCHITECTURE





VERIFIED VIEW 6 - EXISTING

TAKEN FROM THE POINT ON THE EXISTING UNMADE FOOTPATH CROSSING THE SITE FROM NORTH-WEST TO SOUTH EAST, WHERE THE LAND STARTS TO DROP TOWARDS THE HOUSES BUILT ON THE NORTH SIDE OF SKIPTON OLD ROAD IN THE SOUTH-EAST CORNER OF THE SITE.

Rev. Date Details	Drawn Checked
PLANNING	
Project/Cilent	Project No:
LAND TO EAST OF	2029
WINDERMERE AVE	Dwg No Rev
COLNE, PENDLE	4006
ACCRUE CAPITAL	Scale:
	NTS
Drawing.	North:
	Drawn By Date
VIEW 6	CPL 14.09.22
	Checked By Date CPL 14.09.22

CPL ARCHITECTURE



THAN THE INTRODUCTION OF A SUDS DRAINAGE DITCH IN THE FOREGROUND AND THE PRESENCE OF SOME TREE PLANTING TO THE SOUTH-EAST CORNER OF THE SITE AND PLANTING TO ENHANCE THE LINE OF TREES ON THE SOUTHERN BOUNDARY.




VERIFIED VIEW 8 - EXISTING

TAKEN FROM THE HIGHEST POINT ON THE EXISTING UNMADE FOOTPATH RUNNING FROM NORTH-WEST TO SOUTH-EAST ACROSS THE SITE. THIS VIEW AFFORDS A VIEW ACROSS THE CONSERVATION AREA LOOKING SOUTH-EAST.

Rev. Date Details	Drawn Checked	
PLANNING		
Project/Cilent	Project No.	
LAND TO EAST OF	2029	
WINDERMERE AVE	Dwg No Rev	
COLNE, PENDLE	4008	
ACCRUE CAPITAL	Scale:	
	NTS	
Drawing.	North:	
	Drawn By Date	
VIEW 8	CPL 14.09.22	
	Checked By Date CPL 14.09.22	

CPL ARCHITECTURE

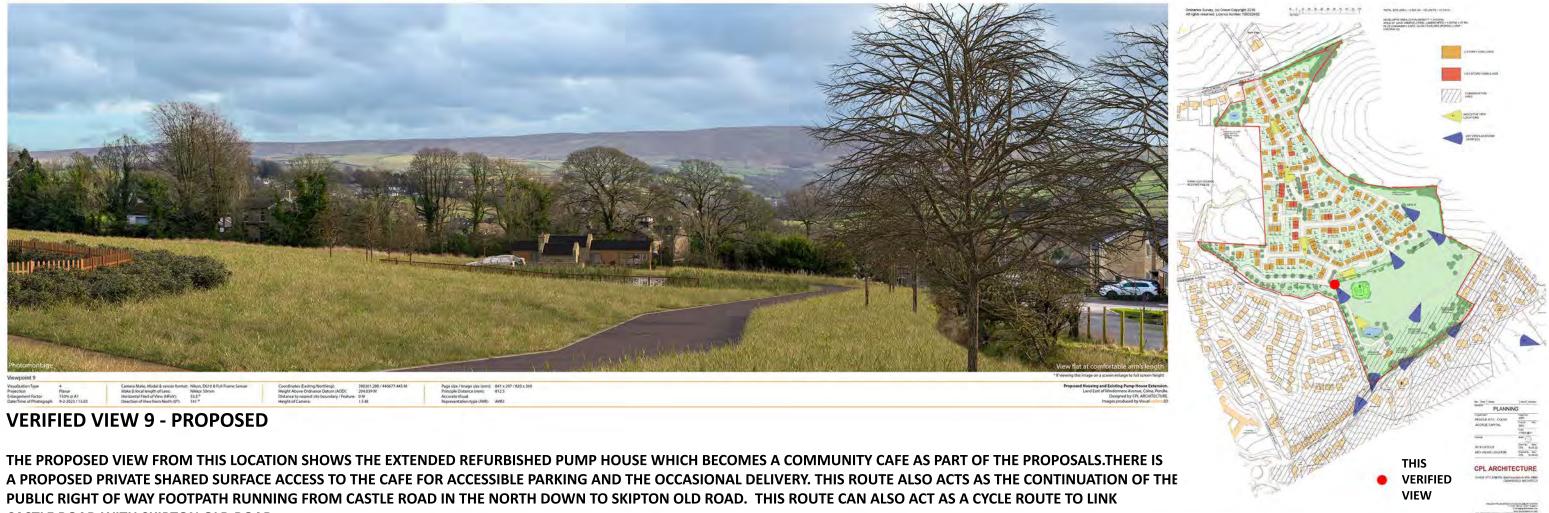

CASTLE ROAD WITH SKIPTON OLD ROAD.



VERIFIED VIEW 9 - EXISTING

Cylindrical 96% @ A1

Make & focal length of Lens: Horizontal Filed of View (HFoV):

Nikkor 90°

TAKEN FROM THE POINT ON THE EXISTING UNMADE FOOTPATH RUNNING FROM NORTH TO SOUTH ACROSS THE SITE WHERE THE VIEW OVER THE CONSERVATION AREA APPEARS FROM BEHIND THE NEW HOUSING DEVELOPMENT BY MCDERMOTT HOMES. THIS IS WHERE THE PATH ROUTE CROSSES THROUGH A DITCH LINE AND HEADS DIRECTLY DOWN TO SKIPTON OLD ROAD. THE EXISTING DERELICT PUMP HOUSE IS CLEARLY SEEN.

Rev. Date Details	Drawn Checked
PLANNING	
Project/Client	Project No.
LAND TO EAST OF	2029
WINDERMERE AVE	Dwg No Rev
COLNE, PENDLE	4009
ACCRUE CAPITAL	Scale:
	NTS
Drawing.	North:
KEY VERIFIED WINTER VIEW 9	
	CPL 14.09.22
	Checked By Date CPL 14.09.22

CPL ARCHITECTURE



VERIFIED VIEW 10 - EXISTING

TAKEN FROM A DISTANT FOOTPATH TO THE SOUTH EAST OF THE SITE ON THE SOUTH SIDE OF SKIPTON OLD ROAD AND WITHIN THE CONSERVATION AREA. THIS UNMADE FOOTPATH RUNS EAST TO WEST AND THERE IS A GLIMPSE VIEW OF THE UPPER PARTS OF THE PROPOSED DEVELOPMENT SITE.

THIS VIEW IS FRAMED BY THE EXISTING DWELLINGS ON THE SOUTH SIDE OF SKIPTON OLD ROAD AND HAS VARIOUS TREES WITHIN THE SETTING.



THE PROPOSED VIEW FROM THIS LOCATION SHOWS DISTANT ROOFSCAPE OF THE PROPOSED DEVELOPMENT ALONGSIDE ADDITIONAL TREES TO BE PLANTED AS PART OF THE PROPOSALS. THE ROOFSCAPE FOLLOWS THE LINE OF THE DISTANT HORIZON WITH THE IMPACT BEING MINIMAL AND OF NO MATERIAL HARM TO THE SETTING OR APPEARANCE OF THE CONSERVATION AREA.





Rev. Date Details	Drawn Checked
PLANNING	
Project/Client:	Project No:
LAND TO EAST OF	2029
WINDERMERE AVE	Dwg No: Rev.
COLNE, PENDLE	3010
ACCRUE CAPITAL	Scale:
	NTS
Drawing: KEY VERIFIED VIEW 10	North:
	CPL 14.09.22
	Checked By: Date CPL 14.09.22

CPL ARCHITECTURE

CHRIS LITTLEMORE BA(Hons) BArch MSc RIBA CHARTERED ARCHITECT

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